



Distribution - To all Planholders

Addendum No. 01 (One)

Date: 05/09/2025

Project: IN000A Site - Parking Lots 28 & 93 Repairs and Modifications

Owner: The Trustees of Indiana University

IU Project No: 20240389

The original specifications and drawings dated May 2025 for the project referenced above are amended as noted in Addendum No. 1. Receipt of this Addendum and any subsequent Addenda must be acknowledged on the Proposal Form. This section of the Addendum consists of 2 (two) items and 6 (six) attachments.

Bid Form:

#### Change:

- The "Alternate Proposals" Section of the Bid Form has been updated to include the alternate use of pavers.

Specification Items:

None

Drawing Items:

1.1 Drawing Sheet Name: Cover Page Drawing Sheet number: C-001

#### Change:

- Update to cover page index adding landscape plans
- Update to cover page index adding lighting plans
- Update to cover page changing owner to the trustees of Indiana University





**Drawing Sheet Name: Existing Conditions** 

Drawing Sheet Number: S-001

#### Change:

- Update to existing conditions changing colors on structure labels

Drawing Sheet Name: Demo Plan Drawing Sheet Number: D-101

#### Change:

- Update to demo plan adding note for existing wall to be removed
- Update to demo plan adding note for existing wall to remain

Drawing Sheet Name: Site Plan Drawing Sheet Number: C-101

#### Change:

- Update to site plan changing the bollards to the north of the west curb ramp to be retractable
- Update to site plan changing curb to be flush with the walk
- Update to site plan extension of sidewalk next to the north entrance
- Update to site plan adjusted the curb line at the north entrance
- Update to site plan adjusted the north curb ramp around the existing wall to remain
- Update to site plan removed one parking spot at ramp
- Update to site plan adjusted striping

Drawing Sheet Name: Grading Plan Drawing Sheet Number: C-201

#### Change:

- Update to grading plan adjusted grades at the curb ramp
- Update to grading plan updated grades at the north entrance

20240389 - IN000A Site – Parking Lots 28 & 93 Repairs and Modifications The Trustees of Indiana University

Addendum No. 1 (One) – May 9, 2025





Drawing Sheet Name: Landscape Plan

Drawing Sheet Number: L-500

Add

Drawing Sheet Name: Landscape Plan

Drawing Sheet Number: L-501

Add

Drawing Sheet Name: Landscape Details

Drawing Sheet Number: L-520

Add

Drawing Sheet Name: Landscape Details

Drawing Sheet Number: L7.00

Add

Drawing Sheet Name: Landscape Details

Drawing Sheet Number: L7.10

Add

Drawing Sheet Name: Information Drawing Sheet Number: ES-001

Add

Drawing Sheet Name: Electrical Demolition Site Plan

Drawing Sheet Number: ES-101

Add





Drawing Sheet Name: Electrical Site Plan

Drawing Sheet Number: ES-201

Add

Drawing Sheet Name: Landscape Plan

Drawing Sheet Number: L510

Add

Drawing Sheet Name: Landscape Plan

Drawing Sheet Number: L511

Add

Drawing Sheet Name: Landscape Plan

Drawing Sheet Number: L520

Add

Drawing Sheet Name: Landscape Details

Drawing Sheet Number: L7.00

Add

Drawing Sheet Name: Information Drawing Sheet Number: ES-001

Add

Drawing Sheet Name: Electrical Demolition Site Plan

Drawing Sheet Number: ES-101

Add





Drawing Sheet Name: Electrical Site Plan

Drawing Sheet Number: ES-201

Add

Prepared by: Anhibited

Robert Santos, PE

Attachments: Bid Form

Ball Hall Set

C-001

S-001

D-101

C-101

C-201

L-500

L-501

L-520

L-7.00

L-7.10

ES-001

ES-101

ES-201





#### Bryce & Ott Set

L-500

L-501

L-520

L-7.00

L-7.10

ES-001

ES-101

ES-201

IU Project 20240389

#### **BID FORM**

for

IN000A Site – Parking Lots 28 & 93 Repairs and Modifications Indiana University Indianapolis Indianapolis, Indiana IU 20240389

TO: The Trustees of Indiana University Bloomington, Indiana

\*\*Submit bid online via www.iuplanroom.com\*\*

| FROM:   |   |
|---|---|
| Bidder's Name   |   |
| Address   |   |
| City, State, Zip Code   |   |
| Phone Number  | FAX Number  |
| CONTACTS:  Bid / Contract Information: Name:  |   |
| Phone:  |   |
| Proposed Project Manager: Name:   |   |
| Phone:  | E-mail:   |
| Indicate if your firm is a certified minority-, If "Yes", please attach a copy of certification FOR: Unified Bid to include General, Med Bidders: |   |
| LUMP SUM BASE BID   |   |
| a complete understanding of the Bidding Do hereinafter, for IN000A Site – Parking Lots on the Indiana University Indianapolis camp                | derstanding of existing conditions at the Project Site and cuments, including any Addenda acknowledged 28 & 93 Repairs and Modifications us, as prepared by JQOL, hereby proposes to complete with the requirements of the Bidding documents, for the |
|   | Dollars \$  |
| (written amount)  | (numerals)  |

#### **MAJOR SUBCONTRACTORS**

Alternate No. 1:

(Add) (Deduct)

Subcontractors and other persons and organizations proposed by the Bidder and accepted by the Owner and the Owner's Representative must be used on the work for which they were proposed and accepted and shall not be changed except with the written approval of the Owner and the Owner's Representative.

If requested, the supplemental Subcontractors and Products List will be submitted by email to the Owner, <a href="mailto:bidtab@iu.edu">bidtab@iu.edu</a>, and JQOL, rsantos@jqolusa.com within 48 hours of the bid opening. The understanding of the Owner and the design team is that these same Major Subcontractors will be the same subcontractors listed below.

The Contractor proposes to utilize the following primary subcontractors for the work indicated.

<u>List one major subcontractor per trade</u>. Any deviation could result in the Owner removing the bid from consideration.

Indicate which are certified by the State of Indiana as an MBE, WBE, or VBE company by circling the M/W/VBE after the name.

| Concre | te Subcontractor   | :                                | _M/W/VBE    |
|--------|--|----------------------------------|-------------|
| Asphal | t Subcontractor  | :                                | M/W/VBE     |
| Haul T | rucking Subcontractor  | :                                | M/W/VBE     |
| ALTE   | RNATE PROPOSALS  |                                  |             |
| 1.     | Alternate proposals are requested under Alternate Specification Index)   | ates of the Bidding Documents.   | . (See      |
| 2.     | The alternate proposal shall indicate the amour Sum Base Bid if the alternate proposal is accept   |                                  | om the Lump |
| 3.     | The alternate proposal shall include all costs no<br>materials or items indicated for the alternate properations, administration, overhead, profit, an | oposal, including materials, lab |             |
| 4.     | The alternate proposal shall also include all cost other Separate Contracts) that will be made necessary.  | `                                | 0           |
| 5.     | The Bidder shall submit prices for all the altern Cross out (Add) or (Deduct) as applicable. If t Base Bid, write in "No Change".                      |                                  |             |

following projects: 20240389-AND-20230562.

(written amount)

Credit to this project if the same general contractor is awarded both of the

IN000A Site – Parking Lots 28 & 93 Repairs and Modifications IU Indianapolis

IU Project 20240389

| Alternate No. 2: | Use of pavers in lieu building entry. | of sod at Lot #28 | for triangular area adjacent to |  |
|------------------|---------------------------------------|-------------------|---------------------------------|--|
| (Add) (Deduct)   |                                       |                   | Dollars \$                      |  |
| LINUTE DELICEC   | (written amount)                      | (numerals)        |                                 |  |

#### <u>UNIT PRICES</u>

- 1. The following Unit Prices shall include all costs necessary for the complete installation of the materials or items indicated, including materials, labor, equipment, operations, administration, overhead, profit and taxes (if applicable).
- 2. These Unit Prices shall be used to determine the costs for changes in the work during the construction period, when agreed upon by the Owner.
- 3. These Unit Prices are submitted as a price per unit of measurement for materials or services added to or deducted from the Contract Sum by appropriate modification, if estimated quantities of Work required by the Contract Documents are increased or decreased.
- 4. The Bidder shall submit one Unit Price for each of the following items, plus any other Unit Prices requested in the Bidding Documents, in the manner indicated.

| <u>Item</u>   | <u>Unit</u> | <u>Price</u> |
|---|-------------|--------------|
| 1. Asphalt mill and resurface                       | Square Yard | \$           |
| 2. Full depth replacement of asphalt and stone base | Square Yard | \$           |
| 3. Broom finish concrete: Color IU Beige with       |             |              |
| Stone Base  | Square Foot | \$           |

#### TAX EXEMPTIONS

The undersigned Bidder has informed himself and all his prospective sub-contractors and suppliers of the tax exempt status of the Owner, as set forth in the General Conditions, and therefore, has <u>not</u> included these taxes in his Lump Sum Base Bid price.

#### **SUBSTITUTIONS**

The undersigned Bidder has based his bid upon the materials, products, articles, equipment, brands, manufacturers and processes described in the Bidding Documents or upon approved equivalents. Proof of equivalency of substitutions is the responsibility of the Bidder, but the Architect/Engineer shall be the sole judge of equivalency. Proposed equivalent substitutions shall be equal in all respects to the requirements of the Bidding Documents, including but not limited to the design, quality, physical size, performance characteristics, strength, previous history of use, and to the method of installation, attachment, or connection to related or adjoining work. Determination of equivalency of proposed substitutions shall be by the Architect/Engineer, before the bid opening date, as described in paragraph entitled "Substitutions" in the Instructions to Bidders.

#### **COMPLETION DATE**

The Undersigned Bidder agrees to coordinate and expedite his work and shall take into consideration any lead time and schedule parameters with all contractors, and that this Work will be completed no later than **August 15, 2025.** 

IU Project 20240389

#### **ASSIGNMENT OF COORDINATION**

The undersigned Bidder agrees to the assignment of Mechanical and Electrical work to the successful General Contractor for the responsibility of complete coordination of the work as stated in the Instructions to Bidders.

#### PERFORMANCE AND PAYMENT BOND

The undersigned Bidder agrees, if awarded the Contract, to deliver to the Owner a satisfactory Performance Bond, in the full amount (100%) of the total Contract price, not later than the date of execution of the contract. The cost of the Bond shall be included in the Lump Sum Base Bid contained in this Proposal.

#### SUPPLEMENTAL AND REQUIRED DOCUMENTS

Bid Security; State Form 96 (Revised 2013); Written Drug Testing Program, which must be in full compliance with IC 4-13-18; a completed Minority, Women's and Veteran's Business Enterprise Participation Plan; Contractor Asbestos Certification; Asbestos Protocol for Contractors.

The following Addenda have been received by the undersigned Bidder; and all costs resulting from

#### **ADDENDA**

| these | Addenda have been included in the pr | reparation of this Bid Form: |
|-------|--------------------------------------|------------------------------|
|       | Addendum No Dated                    | i                            |
|       | Addendum No Dated                    | i                            |
|       | Addendum No Dated                    | i                            |
| SIGN  | IATURES                              |                              |
| 1.    | When a Bidder is an Individual:      |                              |
|       | Witness                              | Bidder                       |
|       | Date:                                | Address:                     |
| 2.    | When a Bidder is a Partnership:      | Name of Partnership          |
|       | Date:                                | Address:                     |
|       | Partner                              | Partner                      |

**3.** 


| When Bidder is a Corporation: | Name of Corporation |
|-------------------------------|---------------------|
| Date:                         | Address:            |
|                               | By:President        |
| Attest:Secretary              |                     |
|                               | CORPORATE SEAL      |

**END** 

\*\*Submit bid online via www.iuplanroom.com\*\*

# INDIANA UNIVERSITY INDIANAPOLIS - PARKING LOT IMPROVEMENTS

INDIANA JOB NO. 20240389: 980 INDIANA AVE INDIANAPOLIS, 46202

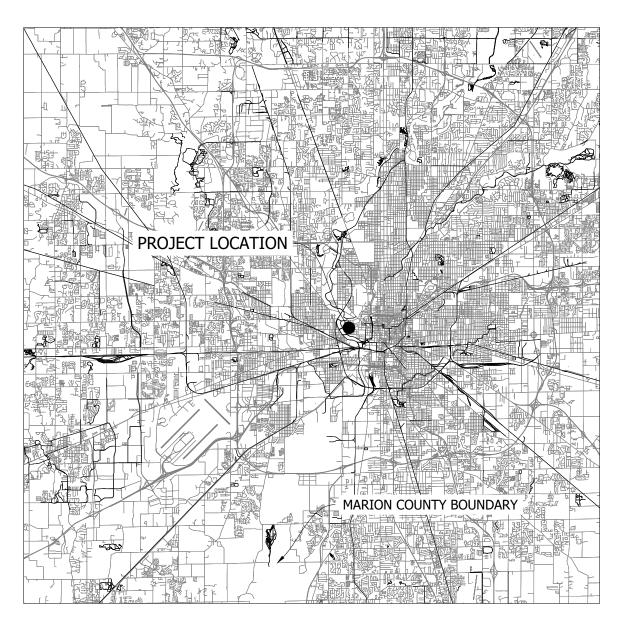

COUNTY LOCATION MAP SCALE: 1" = 20.000'

#### PROJECTS:

(A) 20240389 INDIANA UNIVERSITY INDIANAPOLIS - BRYCE & OTT (980 INDIANA AVE)

#### PROJECT LOCATION

PROJECT A IS LOCATED TO THE WEST OF INDIANA AVE WITH THE NEAREST LARGE INTERSECTION AS INDIANA AVE AND UNIVERSITY BLVD.

#### TEMPORARY BENCHMARKS:

CONTROL POINT 100 IS A REBAR WITH A RED PLASTIC CAP LABELED "CONTROL" SET IN THE GRASS FOUND APPROXIMATELY 186.3 FEET SOUTH OF THE APPROXIMATE CENTER OF THE INTERSECTION OF WEST 10TH STREET AND INDIANA AVENUE AND APPROXIMATELY 401.6 FEET NORTHWEST OF THE APPROXIMATE CENTER OF THE INTERSECTION OF INDIANA AVENUE AND UNIVERSITY BOULEVARD.

ELEV. 704.52 (NAVD 88)

CONTROL POINT 101 IS A REBAR WITH A RED PLASTIC CAP LABELED "CONTROL" SET IN THE GRASS FOUND APPROXIMATELY 221.0 FEET SOUTHWEST OF THE APPROXIMATE CENTER OF THE INTERSECTION OF WEST 10TH STREET AND INDIANA AVENUE AND APPROXIMATELY 578.1 FEET NORTHWEST OF THE APPROXIMATE CENTER OF THE INTERSECTION OF INDIANA AVENUE AND UNIVERSITY BOULEVARD.

ELEV. 704.81 (NAVD 88)

CONTROL POINT 102 IS A REBAR WITH A RED PLASTIC CAP LABELED "CONTROL" SET IN THE GRASS FOUND APPROXIMATELY 424.6 FEET SOUTHEAST OF THE APPROXIMATE CENTER OF THE INTERSECTION OF WEST 10TH STREET AND INDIANA AVENUE AND APPROXIMATELY 167.1 FEET WEST OF THE APPROXIMATE CENTER OF THE INTERSECTION OF INDIANA AVENUE AND UNIVERSITY BOULEVARD.

ELEV. 704.20 (NAVD 88)

| DRAWING                         | INDEX        |
|---------------------------------|--------------|
| Sheet Title                     | Sheet Number |
| COVER PAGE                      | C-001        |
| GENERAL NOTES                   | C-002        |
| EXISTING CONDITIONS             | S-001        |
| DEMO PLAN                       | D-101        |
| SITE PLAN                       | C-101        |
| SITE DETAILS                    | C-102        |
| SITE DETAILS                    | C-103        |
| GRADING PLAN                    | C-201        |
| STORM PLAN                      | C-301        |
| STORM PLAN & PROFILES           | C-302        |
| STORM STRUCTURE TABLE           | C-303        |
| STORM & GRADING DETAILS         | C-304        |
| STORM & GRADING DETAILS         | C-305        |
| STORM & GRADING DETAILS         | C-306        |
| STORM & GRADING DETAILS         | C-307        |
| STORM & GRADING DETAILS         | C-308        |
| UTILITY PLAN                    | C-400        |
| SANITARY PROFILES               | C-401        |
| SANITARY PROFILES               | C-402        |
| SANITARY PROFILES               | C-403        |
| PRE-EROSION CONTROL PLAN        | C-500        |
| POST-EROSION CONTROL PLAN       | C-501        |
| EROSION CONTROL DETAILS         | C-502        |
| SWPPP NOTES (CGSP)              | C-503        |
| LANDSCAPE PLAN                  | L510         |
| LANDSCAPE PLAN                  | L511         |
| LANDSCAPE PLAN                  | L520         |
| LANDSCAPE DETAILS               | L7.00        |
| INFORMATION                     | ES-001       |
| ELECTRICAL DEMOLITION SITE PLAN | ES-101       |
|                                 | EC 201       |

**ELECTRICAL SITE PLAN** 

INDIANAPOLIS DEPARTMENT OF BUSINESS AND NEIGHBORHOOD SERVICES, (BNS), CITY-COUNTY BUILDING
200 E. WASHINGTON STREET, SUITE 107
INDIANAPOLIS, IN 46204
317-327-8700
FINAL PLANS APPROVED APRIL 28 , 2025

#### STORM SEWER INVENTORY


| STURM SEWER INVENTOR           | T        |
|--------------------------------|----------|
| STRUCTURE / PIPE               | QUANTITY |
| RCP, 12-IN.                    | 507 LF   |
| RCP, 15-IN.                    | 201 LF   |
| RCP, 18-IN.                    | 175 LF   |
| RCP, 24-IN.                    | 151 LF   |
| INDOT MANHOLE TYPE C           | 4 EACH   |
| INDOT MANHOLE TYPE J           | 1 EACH   |
| INDOT INLET TYPE F             | 1 EACH   |
| INDOT INLET TYPE A             | 11 EACH  |
| STORMTRAP STORMSETTLER, SSET-5 | 1 EACH   |
|                                |          |

#### WATER QUALITY BMP INFORMATION


| TYPE                           | STATE PLANE COORDINATES |            |  |  |
|--------------------------------|-------------------------|------------|--|--|
|                                | X (EAST)                | Y (NORTH)  |  |  |
| UNDERGROUND DETENTION          | 185072.185              | 1651036.20 |  |  |
| STORMTRAP STORMSETTLER, SSET-5 | 185044.067              | 1651072.48 |  |  |

#### QUANTITIES NOTE:

ANY AND ALL QUANTITY TABLES, NOTES OR VALUES AS SHOWN ON THESE PLANS ARE FOR REFERENCE ONLY. THE PLANS, DETAILS, AND SPECIFICATIONS GOVERN. IT IS THE RESPONSIBILITY OF THE CONTRACTOR TO REVIEW THE ENTIRE CONSTRUCTION SET AND DETERMINE ALL THE FINAL QUANTITIES FOR ALL NECESSARY ITEMS REQUIRED TO COMPLETE THIS PROJECT. THE OWNER OR THE ENGINEER WILL NOT BE HELD LIABLE OR RESPONSIBLE FOR ESTIMATES NOT CONFIRMED BY THE CONTRACTORS. THE CONTRACTOR SHALL VERIFY ALL QUANTITIES PRIOR TO BIDDING AND CONSTRUCTION. IF DISCREPANCIES ARE FOUND, CONTACT THE ENGINEER IMMEDIATELY.

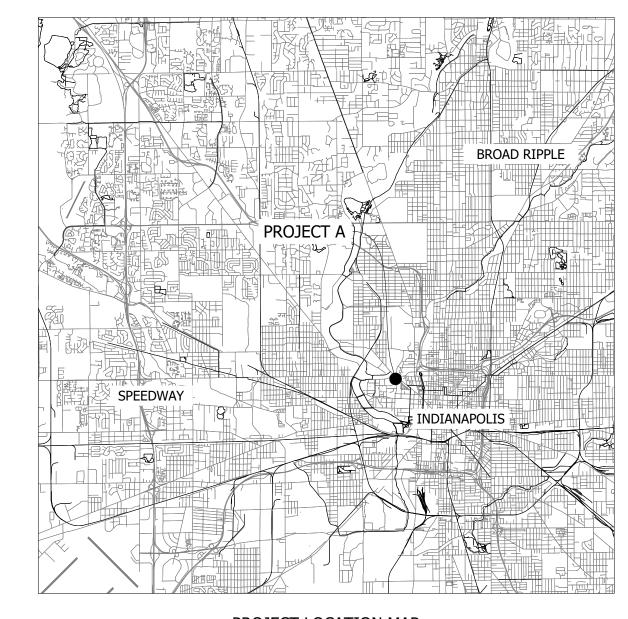


PROJECT LOCATION MAP SCALE: 1" = 10,000'

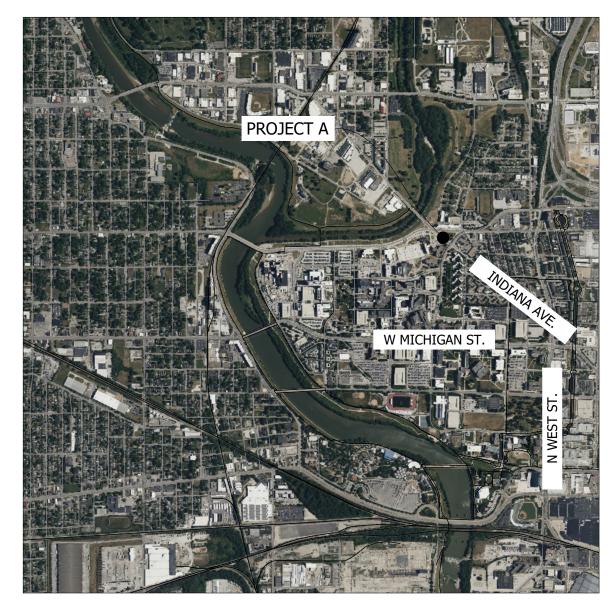

VICINITY MAP SCALE: 1" = 2,000'



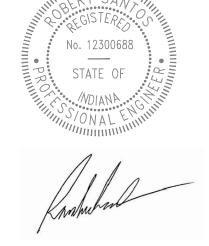

OWNER/DEVELOPER:


ES-201


TRUSTEES OF INDIANA UNIVERSITY 2901 E. DISCOVERY PARKWAY BLOOMINGTON, IN 47408

CIVIL ENGINEER:


JQOL QUALITY OF LIFE 8440 ALLISON POINTE BLVD, INDIANAPOLIS, IN 46250 HTTP://JQOLUSA.COM


ISSUE FOR CONSTRUCTION 05/05/2025

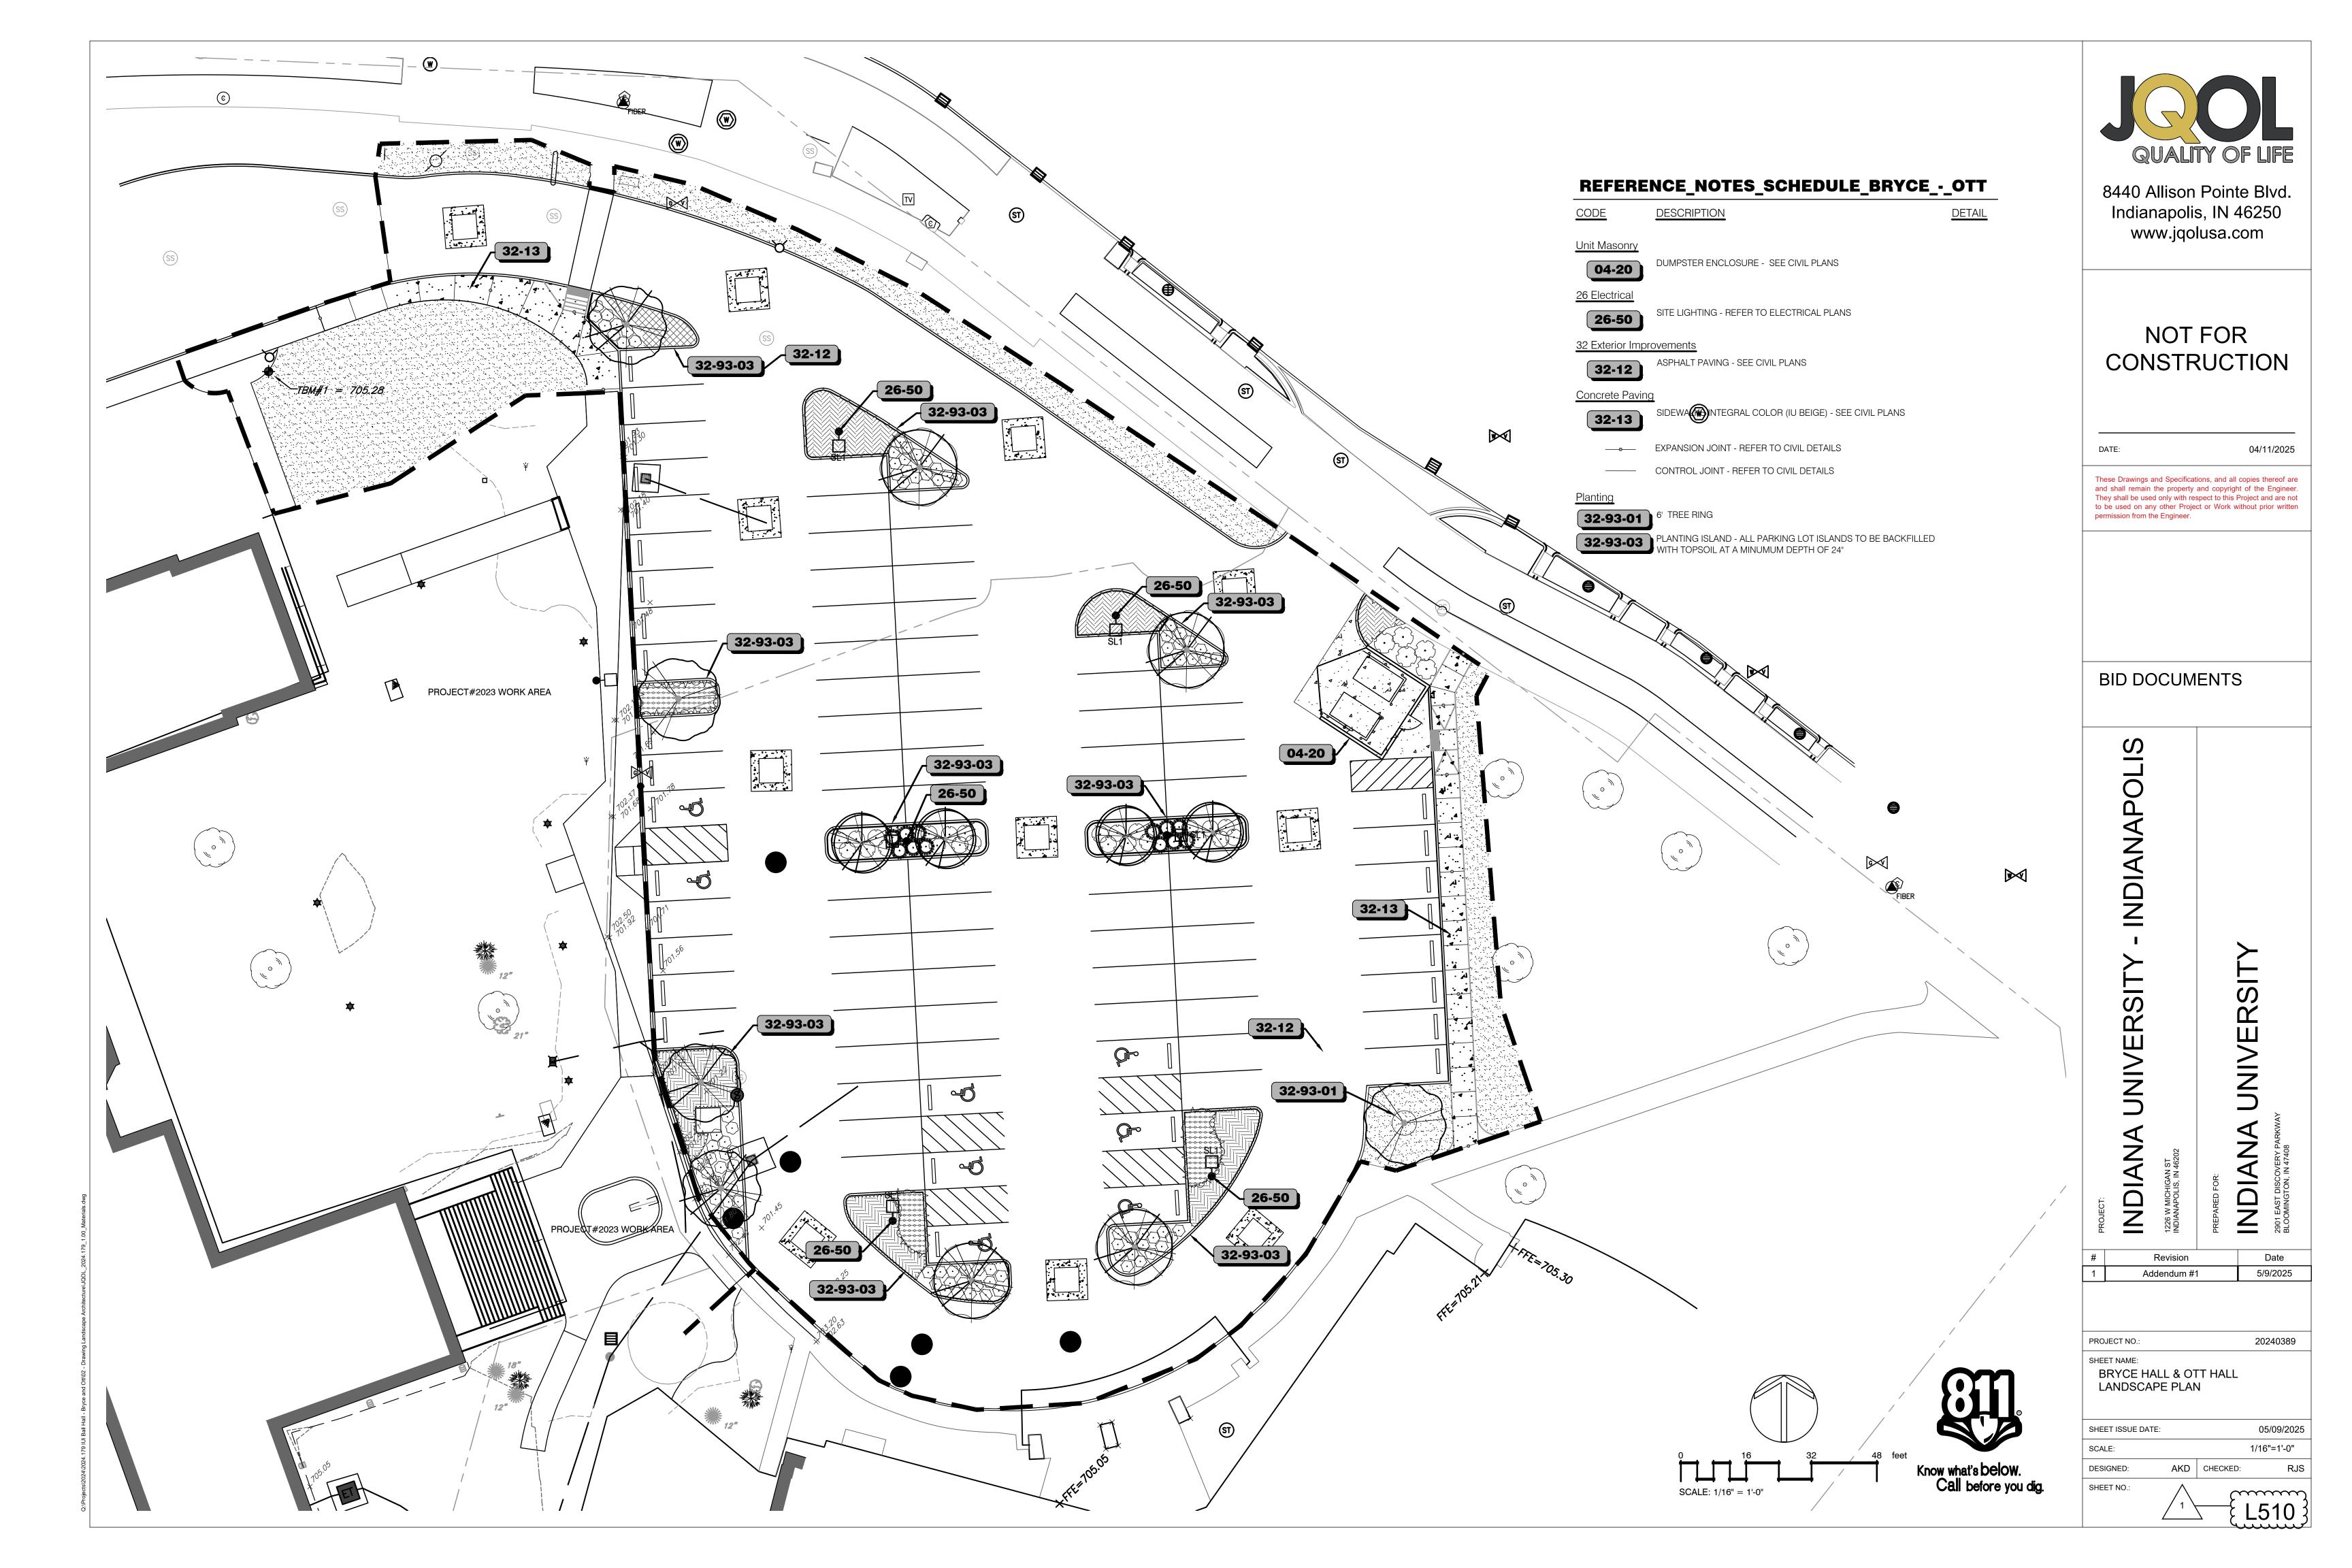

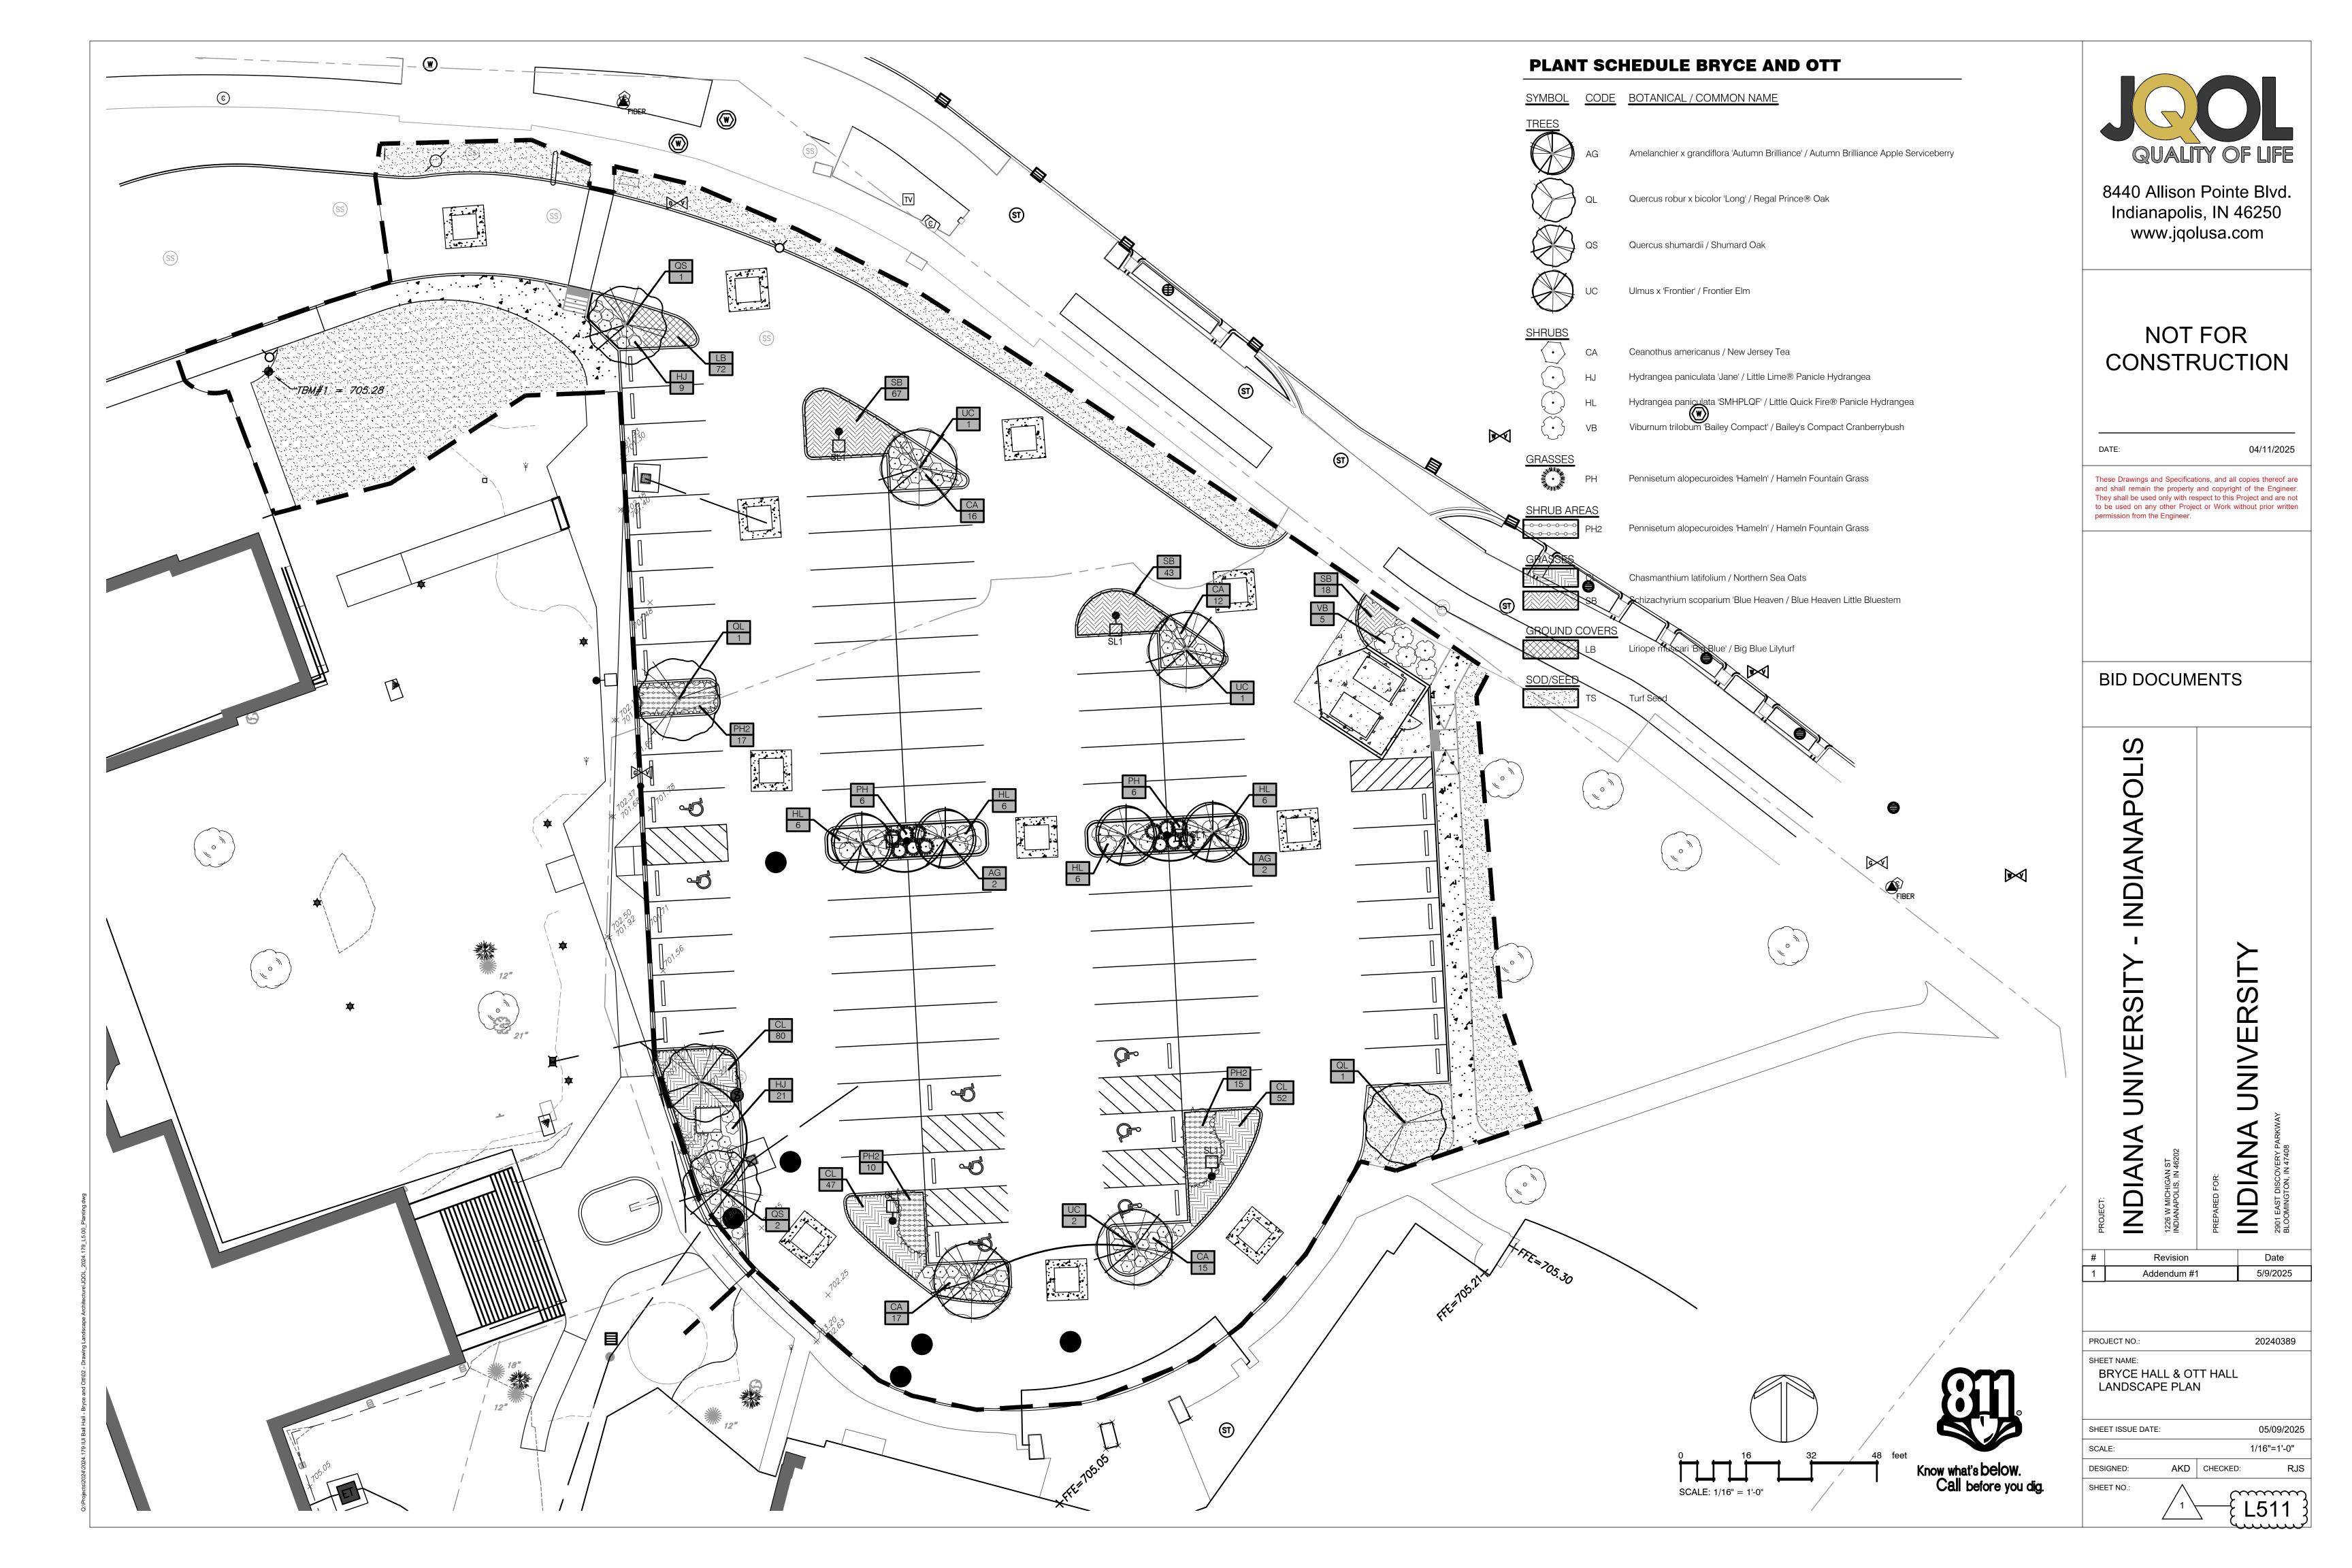


| PLAN                    | IT SCI            | HEDULE BRYCE AND OTT   |           |           |                |                |            |        |                                  |  |
|-------------------------|-------------------|--|-----------|-----------|----------------|----------------|------------|--------|----------------------------------|--|
| SYMBOL                  | CODE              | BOTANICAL / COMMON NAME  | SIZE      | CONTAINER |                |                | QTY        | DETAIL | REMARKS                          |  |
| TREES                   |                   |  |           |           |                |                |            |        |                                  |  |
|                         | AG                | Amelanchier x grandiflora 'Autumn Brilliance' / Autumn Brilliance Apple Serviceberry | 2" Cal.   | В&В       |                |                | 4          |        |                                  |  |
|                         | <b>Q</b> L        | Quercus robur x bicolor 'Long' / Regal Prince® Oak                                   | 2.5" Cal. |           |                |                | 2          |        |                                  |  |
|                         | QS                | Quercus shumardii / Shumard Oak  | 2.5" Cal. | B&B       |                |                | 3          |        |                                  |  |
|                         | UC                | Ulmus x 'Frontier' / Frontier Elm  | 2.5" Cal. | B&B       |                |                | 4          |        |                                  |  |
| SYMBOL                  | CODE              | BOTANICAL / COMMON NAME  | SIZE      | CONTAINER | INSTALL HEIGHT |                | <u>QTY</u> | DETAIL | REMARKS                          |  |
| SHRUBS                  |                   |  |           |           |                |                |            |        |                                  |  |
| $\langle \cdot \rangle$ | CA                | Ceanothus americanus / New Jersey Tea  | 1 gal.    | Pot       | 18"            |                | 60         |        |                                  |  |
| $\bigcirc$              | HJ                | Hydrangea paniculata 'Jane' / Little Lime® Panicle Hydrangea                         | #3        | Pot       | 24"            |                | 30         |        |                                  |  |
|                         | HL                | Hydrangea paniculata 'SMHPLQF' / Little Quick Fire® Panicle Hydrangea                | 3 gal.    | Pot       | 24"            |                | 24         |        |                                  |  |
|                         | VB                | Viburnum trilobum 'Bailey Compact' / Bailey's Compact Cranberrybush                  | 3 gal.    | Pot       | 24"            |                | 5          |        |                                  |  |
| GRASSES                 | <u>S</u>          |  |           |           |                |                |            |        |                                  |  |
|                         | PH                | Pennisetum alopecuroides 'Hameln' / Hameln Fountain Grass                            | #3        | Pot       | 24"            |                | 12         |        |                                  |  |
| SYMBOL                  | CODE              | BOTANICAL / COMMON NAME  | SIZE      | CONTAINER | INSTALL HEIGHT | SPACING        | QTY        | DETAIL | REMARKS                          |  |
| SHRUB A                 | <sup>-0</sup> PH2 | Pennisetum alopecuroides 'Hameln' / Hameln Fountain Grass                            | #3        | Pot       | 24"            | 36" o.c.       | 42         |        |                                  |  |
| GRASSES                 | CL                | Chasmanthium latifolium / Northern Sea Oats  | #1        | Pot       | 18"            | 24" o.c.       | 179        |        |                                  |  |
|                         | SB                | Schizachyrium scoparium 'Blue Heaven / Blue Heaven Little Bluestem                   | #1<br>#1  | Pot       | 18"            | 24" o.c.       | 128        |        |                                  |  |
| SYMBOL                  | CODE              | BOTANICAL / COMMON NAME  | SIZE      | CONTAINER |                | <u>SPACING</u> | QTY        | DETAIL | REMARKS                          |  |
| GROUNE                  | COVERS<br>LB      | Liriope muscari 'Big Blue' / Big Blue Lilyturf                                       | #1        | Pot       |                | 16" o.c.       | 72         |        |                                  |  |
| SOD/SEE                 | D<br>TS           | Turf Seed  | seed      |           |                |                | 5,559 sf   | _      | TURF TYPE FESCUE MIX - HYDROSEED |  |

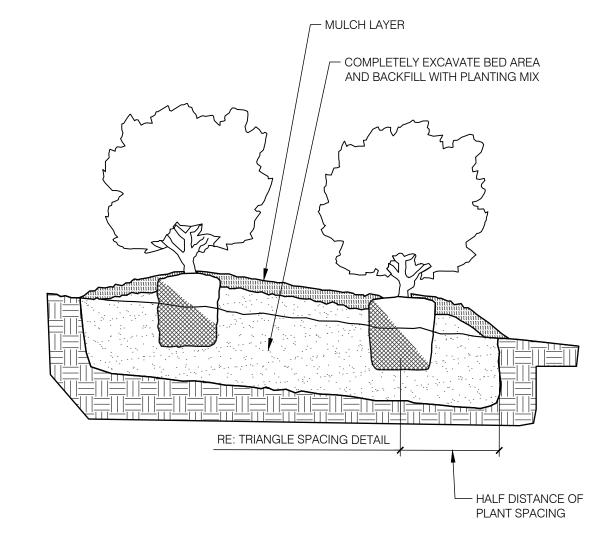

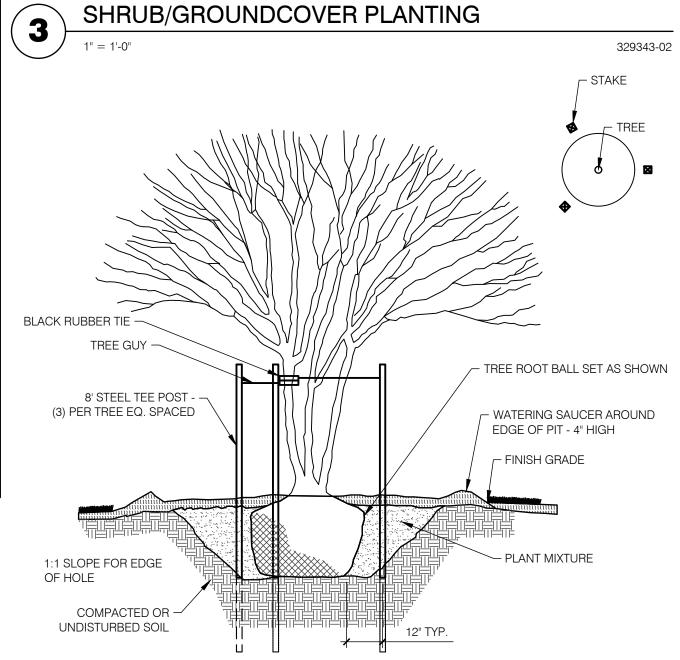

MULTI-TRUNK TREE PLANTING

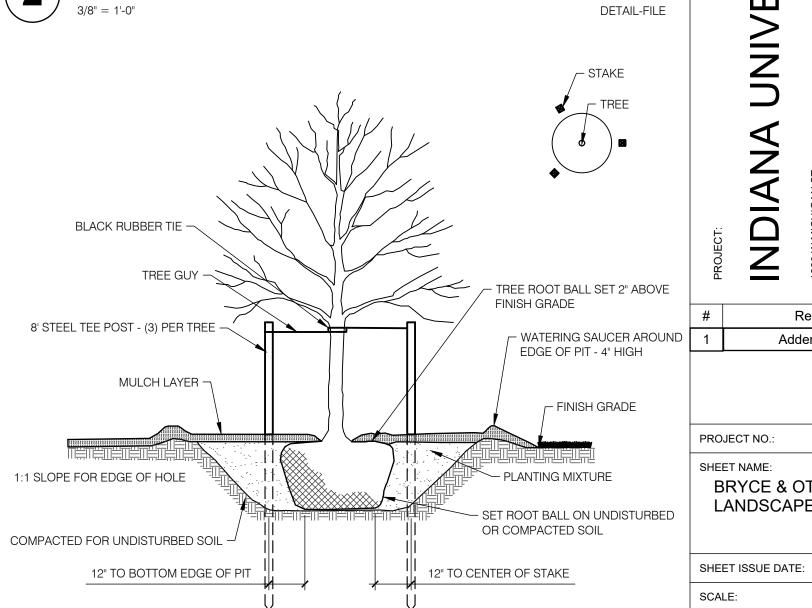



8440 Allison Pointe Blvd. Indianapolis, IN 46250 www.jqolusa.com

#### NOT FOR CONSTRUCTION

04/11/2025

These Drawings and Specifications, and all copies thereof are and shall remain the property and copyright of the Engineer. They shall be used only with respect to this Project and are not to be used on any other Project or Work without prior written permission from the Engineer.

#### **BID DOCUMENTS**

# INDIANA

UNIVERSITY UNIVERSITY


INDIANA INDIANA

Date Revision 5/9/2025 Addendum #1

PROJECT NO.: 20240389

SHEET NAME: BRYCE & OTT PLANT SCHEDULE LANDSCAPE DETAILS


05/09/2025 SCALE: DESIGNED: AKD CHECKED: SHEET NO.:

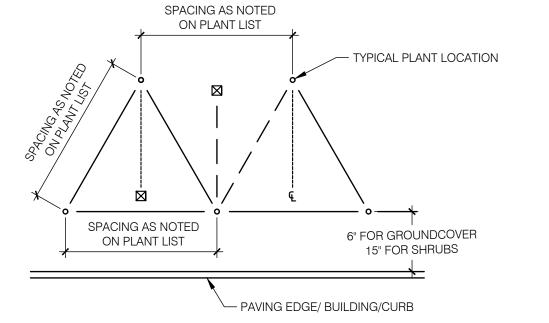


TRIANGULAR SPACING DIAGRAM

329343-05

STANDARD TREE PLANTING DETAIL-FILE

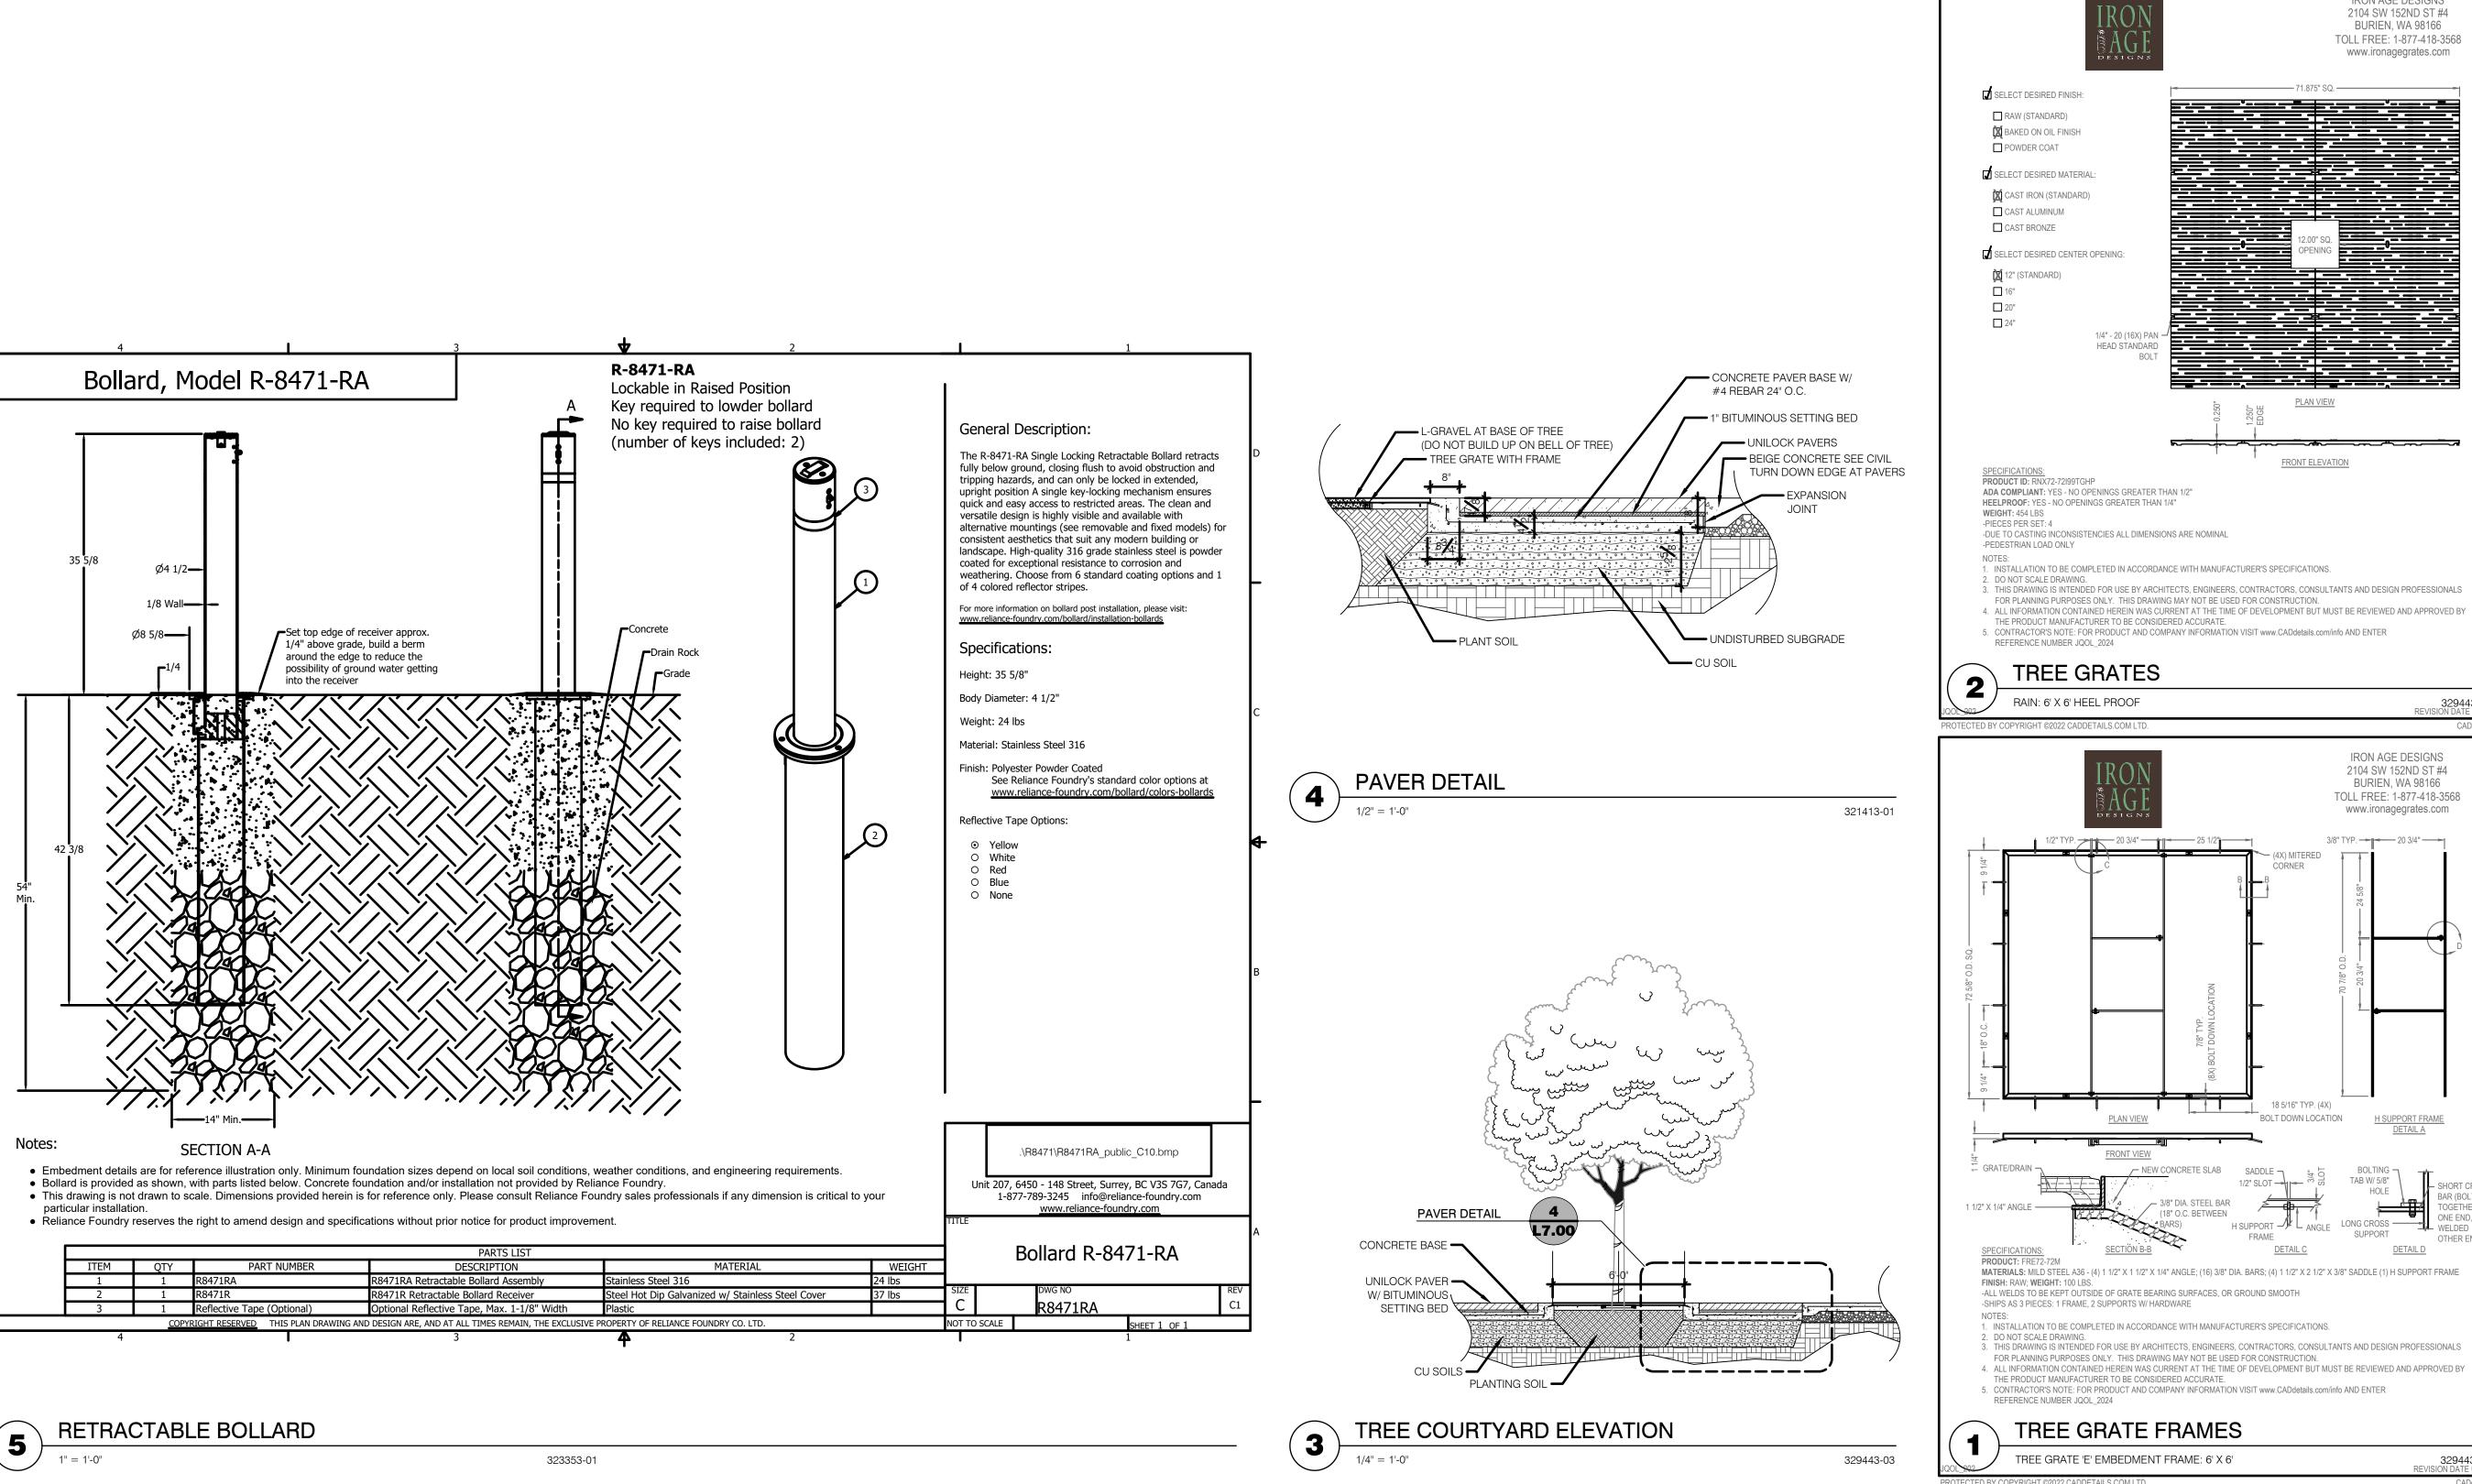


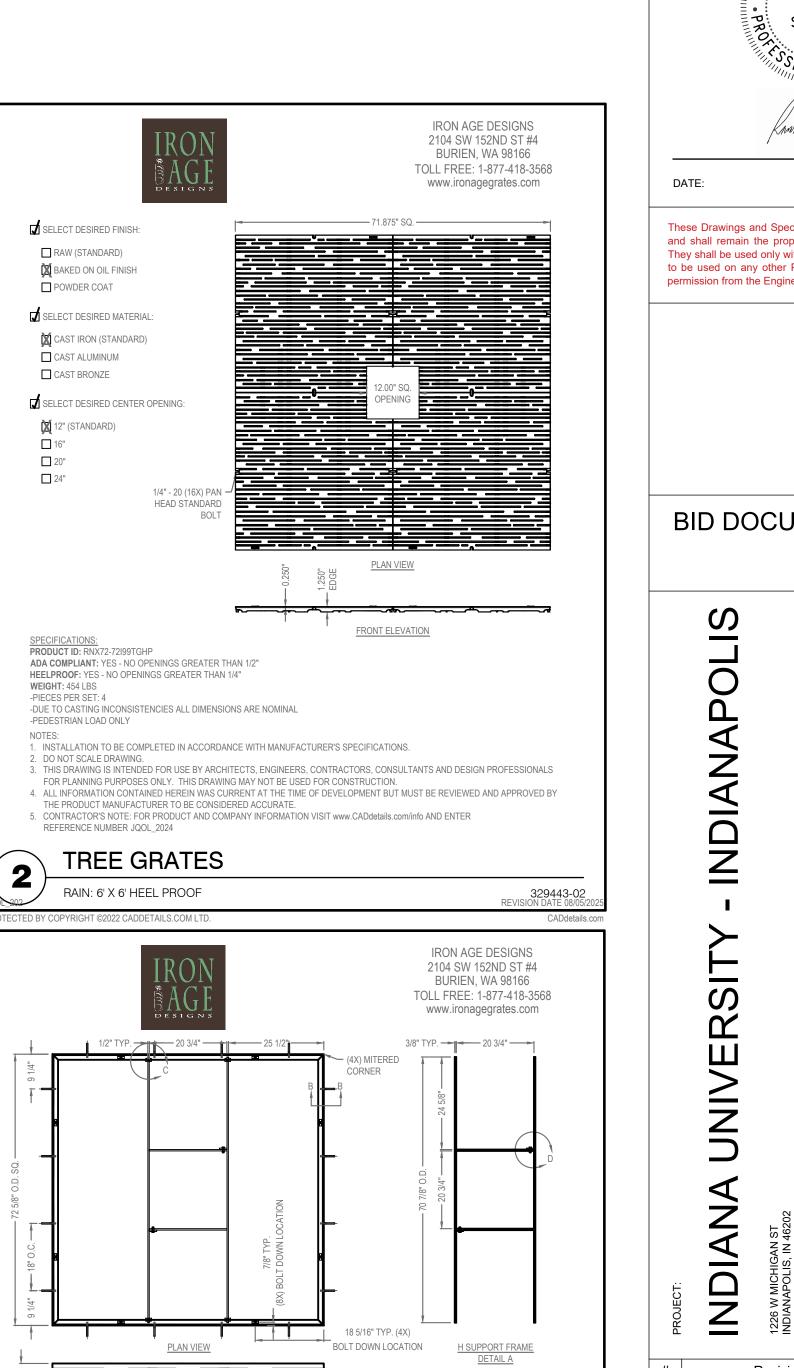

TREE GRATE FRAMES

TREE GRATE 'E' EMBEDMENT FRAME: 6' X 6'

8440 Allison Pointe Blvd. Indianapolis, IN 46250 www.jqolusa.com

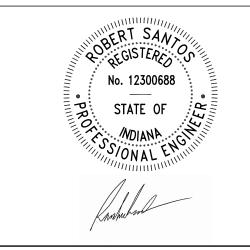

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04/11/2025


**BID DOCUMENTS** 


Date Revision 5/9/2025 Addendum #1

20240389


PROJECT NO.: SHEET NAME: **DETAILS** 

SHEET ISSUE DATE: 05/09/2025 SCALE: 1/16"=1'-0" DESIGNED: AKD CHECKED: SHEET NO.:

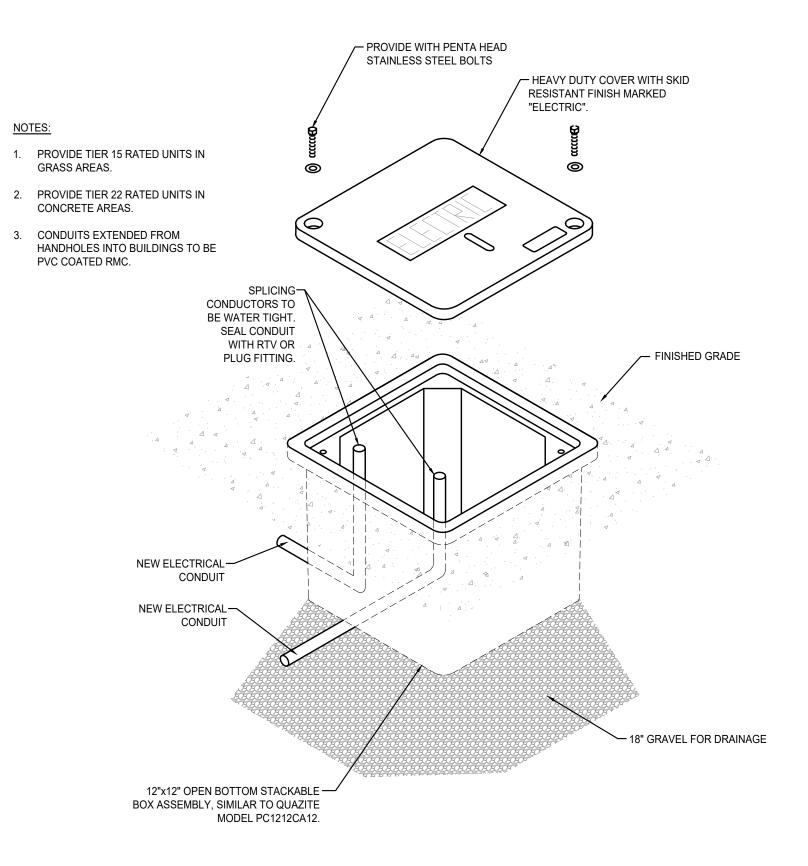

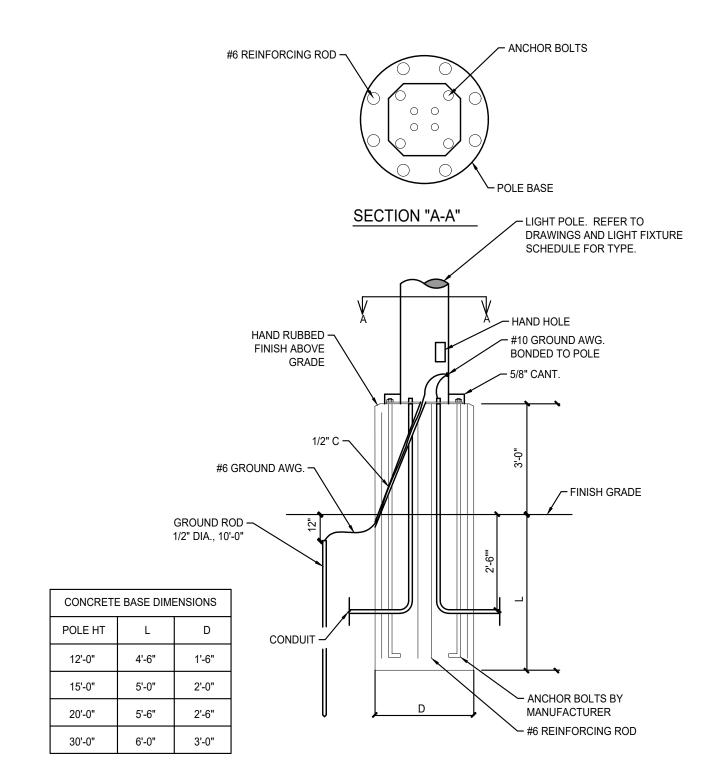

36" RAISED POLE BASE DETAIL

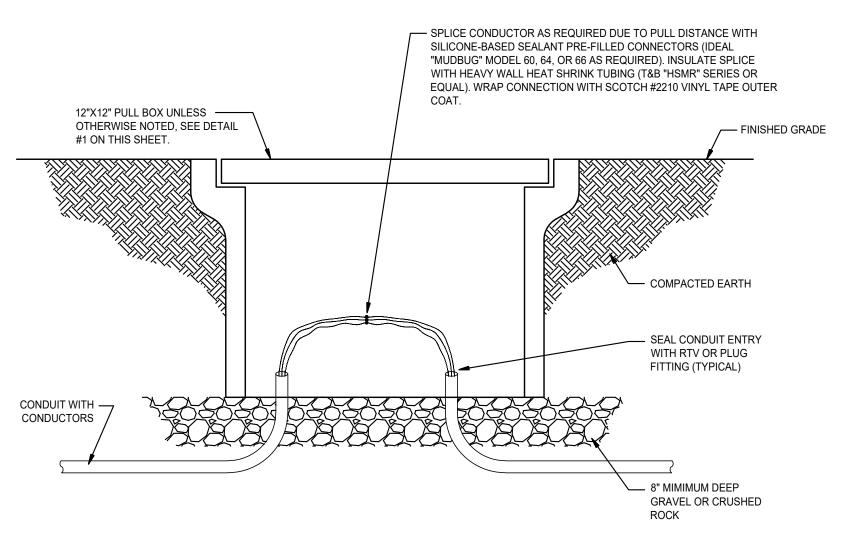

#### **GENERAL ELECTRICAL DEMOLITION NOTES**

- ALL EXISTING EQUIPMENT THAT IS TO REMAIN IS INTENDED TO BE OPERATIONAL AT THE COMPLETION OF THE PROJECT. RECIRCUIT WHERE NECESSARY TO INSURE THIS CONTINUED OPERATION.
- OWNER SHALL HAVE FIRST RIGHT OF REFUSAL ON ALL EQUIPMENT THAT IS TO BE REMOVED.
- THE EXISTING EQUIPMENT SHOWN ON THE DRAWINGS IS BELIEVED TO BE A REASONABLE INDICATION OF THE EXISTING LAYOUT. EXACT QUANTITY AND LOCATION SHALL BE FIELD VERIFIED BY CONTRACTOR.

#### **GENERAL ELECTRICAL NOTES**

- 1. REFER TO ARCHITECTURAL PLANS FOR DIMENSIONS.
- 2. DIMENSIONS SHOWN ON OUTLET BOXES AND DEVICES SHALL BE TO THE BOTTOM OF THE BOX.
- 3. CONDUIT SHOWN TO LIGHT FIXTURES IS SHOWN TO INDICATE SWITCHING AND DOES NOT REPRESENT THE QUANTITY OR EXACT LOCATION OF WIRING AND/OR CONDUIT.
- 4. THE ELECTRICAL LAYOUT DRAWINGS ARE DIAGRAMMATIC IN NATURE. REFER TO ENTIRE CONSTRUCTION DRAWING SET AND SPECIFICATIONS FOR GUIDANCE ON DIMENSIONS, CEILING HEIGHTS, DOOR SWINGS, ROOM FINISHES, STRUCTURAL DETAILS, LOCATIONS OF PIPING, DUCTWORK, STRUCTURAL MEMBERS, AND OTHER OBSTRUCTIONS. INSTALL THE ELECTRICAL SYSTEMS SO AS NOT TO INTERFERE WITH THE INSTALLATION OR FUNCTION OF ANY WORK BY ANOTHER DISCIPLINE.
- 5. ALL DIMENSIONS OF EXISTING DEVICES AND EQUIPMENT ARE APPROXIMATE. CONTRACTOR SHALL MAKE ALL NECESSARY FIELD MEASUREMENTS OF EXISTING STRUCTURES AND EQUIPMENT TO VERIFY DIMENSIONS SHOWN ON THE PLANS. ALL ADDED COSTS TO MODIFY NEW CONSTRUCTION DUE TO A LACK OF COORDINATION AND FIELD MEASUREMENTS SHALL BE BORNE BY THE CONTRACTOR.
- 6. COORDINATE ALL EQUIPMENT WIRING WITH MFR'S REQUIREMENTS. CHANGES REQUIRED FROM THE USE OF PRODUCTS THAT ARE OTHER THAN THE BASIS OF DESIGN SHALL BE BORNE BY THE CONTRACTOR.
- SIZING OF BRANCH CIRCUITS AND FEEDERS FOR EQUIPMENT IS BASED ON DESIGN LOADS. PRIOR TO INSTALLATION, CONFIRM EXACT LOADS WITH RELEASED SHOP DRAWINGS. BRING ANY DISCREPANCIES TO THE ATTENTION OF THE ENGINEER PRIOR TO ROUGH-IN.
- 8. BRANCH CIRCUITS SHALL BE WIRED WITH 3/4"C, 2-#12, 1-#12G, UNLESS NOTED OTHERWISE. NEUTRAL CONDUCTORS SHALL NOT BE SHARED ON BRANCH CIRCUITS.
- 9. WHERE CONDUIT AND WIRING HAS NOT BEEN SHOWN ON THE DRAWINGS, THE ARRANGEMENT AND ROUTING OF LIGHTING AND RECEPTACLE BRANCH CIRCUITS SHALL BE AT THE DISCRETION OF CONTRACTOR IN ACCORDANCE WITH GENERALLY ACCEPTED GOOD PRACTICE, N.E.C. REQUIREMENTS, AND THE FOLLOWING LIMITATIONS:
- 10. EXCEPT WHERE NOTED OTHERWISE, SIZE BRANCH CIRCUIT CONDUCTORS WITHIN THE FOLLOWING MAXIMUM LENGTH LIMITS: (MEASURE TO THE CENTER OF THE LOAD FOR LIGHTING AND TO THE MOST REMOTE OUTLET FOR RECEPTACLE

CIRCUIT BREAKER CIRCUIT LENGTH CONDUCTOR SIZE 120V, 20 A 100 FEET 150 FEET 200 FEET

- 11. PROVIDE #12 AWG MINIMUM FOR BRANCH CIRCUITS. PROVIDE ADDITIONAL DERATING PER N.E.C. TABLES 310-16 THROUGH 310-31 FOR ALL HOME RUNS WITH MORE THAN THREE CURRENT CARRYING CONDUCTORS IN A RACEWAY.
- 12. CONDUITS SHALL BE LIMITED TO A MAXIMUM OF NINE BRANCH CIRCUIT CONDUCTORS OF WHICH A MAXIMUM OF FOUR PHASE CONDUCTORS SHALL BE PERMITTED. GROUNDING CONDUCTORS SHALL NOT BE INCLUDED IN THE COUNT.

| LINE TYPE SCHEDULE  |
|---|
| <br>— · — · — UNDERGROUND COMMUNICATION FEED LINE TYPE AND WEIGHT |
| <br>— — — UNDERGROUND FEED LINE TYPE AND WEIGHT                   |
| NEW POWER LINE WEIGHT   |
| NEW MECHANICAL EQUIPMENT LINE WEIGHT                              |
| NEW LIGHTING LINE WEIGHT  |
| NEW LIGHTING DEVICE LINE WEIGHT                                   |
| NEW EMERGENCY AND FIRE DEVICE LINE WEIGHT                         |
| NEW COMMUNICATION DEVICE LINE WEIGHT                              |
| EXISTING TO REMAIN LINE WEIGHT                                    |
| <br>EXISTING TO BE DEMOLISHED LINE TYPE AND WEIGHT                |

## **ELECTRICAL SYMBOLS SCHEDULE** EXTERIOR POLE MOUNTED FIXTURE, "XX" DENOTES FIXTURE TYPE EXTERIOR POLE, POST MOUNTED FIXTURE, "XX" DENOTES FIXTURE TYPE

|     | LIGHT FIXTURE SCHEDULE   |         |          |                                   |      |     |               |  |         |  |
|-----|--|---------|----------|-----------------------------------|------|-----|---------------|--|---------|--|
| TAG | MANUFACTURER'S CATALOG NUMBER  | VOLTAGE | MOUNT    | MIN.<br>LUMEN<br>OUTPUT<br>*(D/I) | СТ   | CRI | MAX.<br>WATTS | DESCRIPTION  | REMARKS |  |
| SL1 | BEACON #VP-2-320L-145-4K7-5QW-UNV-DB-SCP MCGRAW-EDISON #GLEON SERIES | MVOLT   | NEW POLE | 22,097                            | 4000 | 70  | 146           | DIE CAST ALUMINUM FIXTURE WITH POWDER COAT BRONZE FINISH, PROVIDE ADAPTER AS REQUIRED FOR POLE MOUNTING. PROVIDE BEACON "RSA" SERIES 25'-0" TALL BY 6" DIAMETER MINIMUM ROUND STRAIGHT ALUMINUM WITH DARK BRONZE FINISH. POLE SHALL BE CONSTRUCTED OF SEAMLESS ROUND EXTRUDED ALUMINUM. THE POLE SHAFT SHALL TELESCOPE INTO THE BASE CASTING AND SHALL BE CIRCUMFERENTIALLY WELEDED TOP AND BOTTOM, THE BASE SHALL BE HINGED. FURNISH WITH ROUND ALUMINUM BASE COVER, POLE CAP. REINFORCED HANDHOLE AT +18", AND GROUND LUG LOCATED NEAR HANDHOLE. POLE SHALL BE COMPLETE WITH INTERNAL VIBRATION DAMPERS. PROVIDE CUSTOM MOUNTING PLATE AS REQUIRED. PROVIDE WITH WIRELESS HANDHELD CONFIGURATION TOOL. |         |  |


REMARKS:

#### **GENERAL NOTES:**

- ELECTRICAL CONTRACTOR IS TO PROVIDE ALL NECESSARY HARDWARE AND ACCESSORIES FOR COMPLETE INSTALLATION OF LIGHT FIXTURES ACCORDING TO MANUFACTURER'S RECOMMENDATIONS.
- FULL MODEL NUMBER(S) LISTED ABOVE ARE BASIS OF DESIGN. CONTRACTOR IS RESPONSIBLE FOR DEVIATION FROM BASIS OF DESIGN.
- ELECTRICAL CONTRACTOR IS RESPONSIBLE TO PROVIDE ADDITIONAL CIRCUIT(S) AS REQUIRED FOR MAX. WATTAGE IN EXCESS OF BASIS OF DESIGN.



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05/09/2025

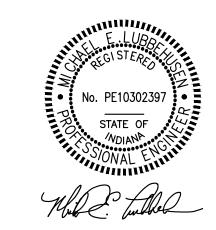INDIAN

INDIANA Revision Date Addendum #1

5/9/2025


PROJECT NO.: NO. 20240389

SHEET NAME: INFORMATION

UNIVE

SHEET ISSUE DATE: 05/09/2025 NO SCALE DESIGNED: SBA CHECKED: SHEET NO .:



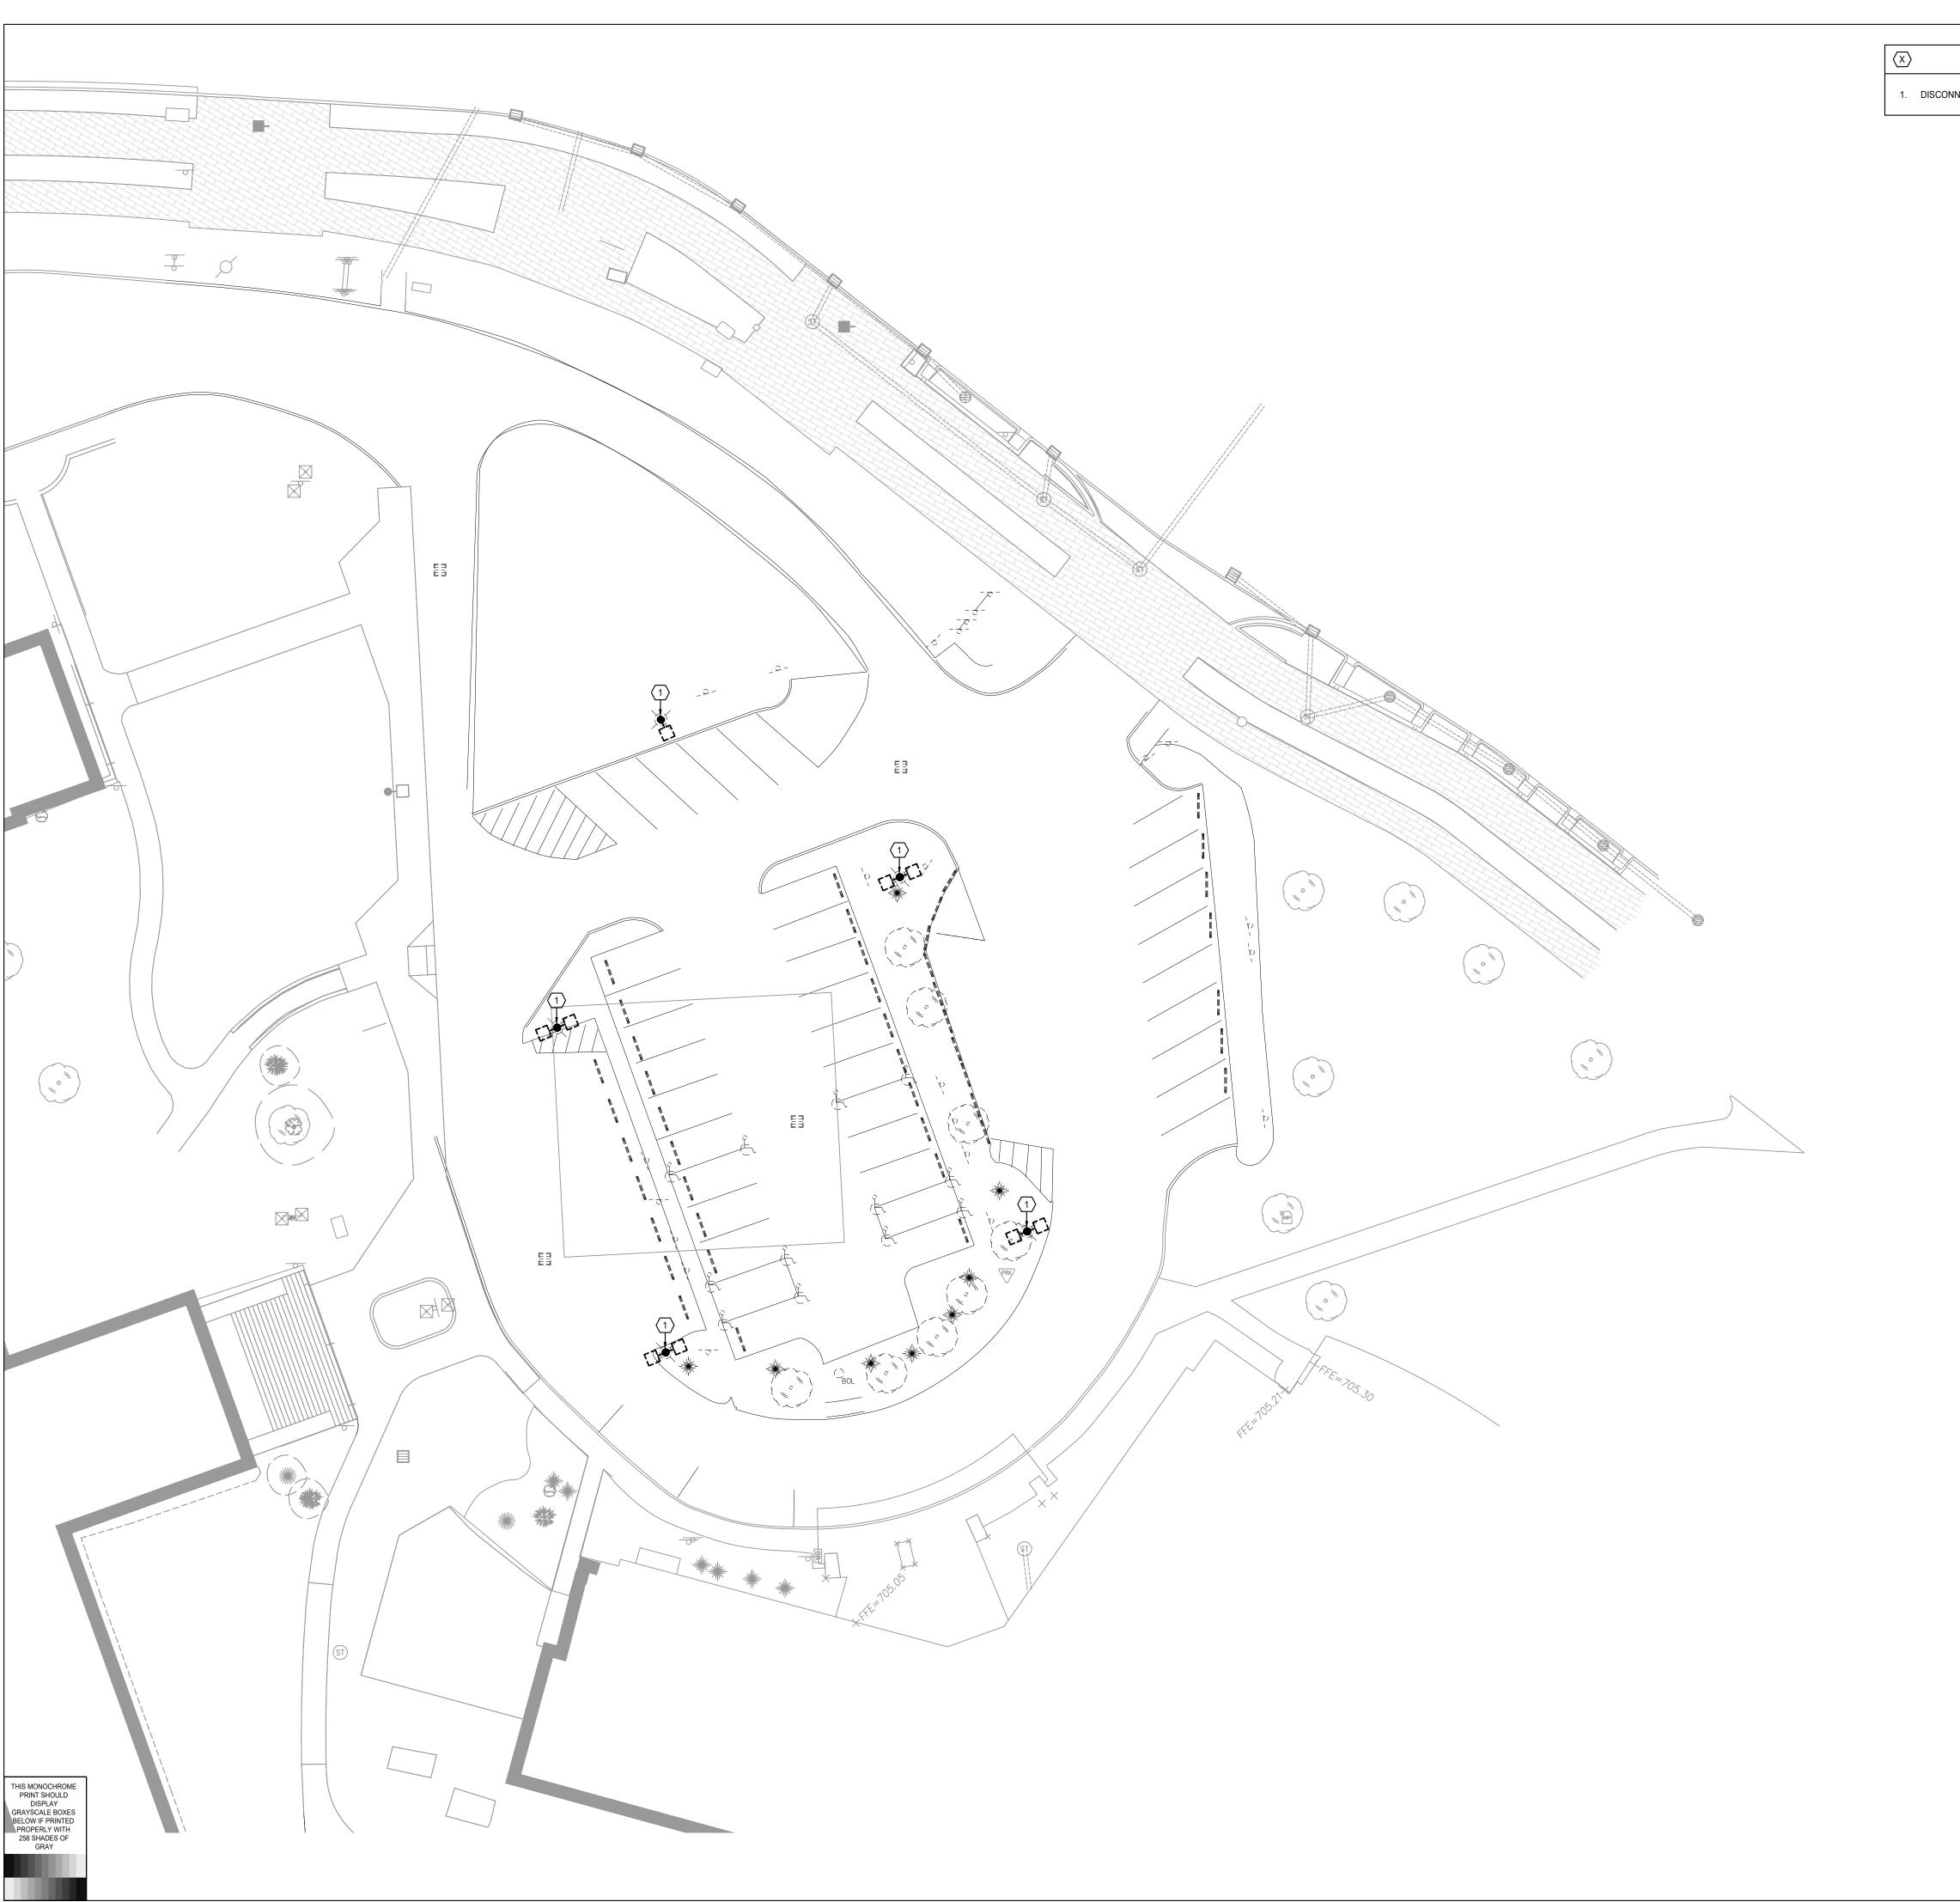

**PLAN NOTES** 

1. DISCONNECT AND REMOVE EXISTING LIGHT FIXTURE, POLE, BRANCH CIRCUITRY, AND POLE BASE COMPLETE.



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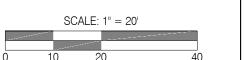
INDIANA


NO. 20240389

| # | Revision    | Date     |
|---|-------------|----------|
| 1 | Addendum #1 | 5/9/2025 |
|   |             |          |

SHEET NAME:
ELECTRICAL DEMOLITION SITE PLAN

| SHEET ISSUE DATE: |     |          | 05/09/2025 |
|-------------------|-----|----------|------------|
| SCALE:            |     |          | 1" = 20'   |
| DESIGNED:         | SBA | CHECKED: | RHA        |



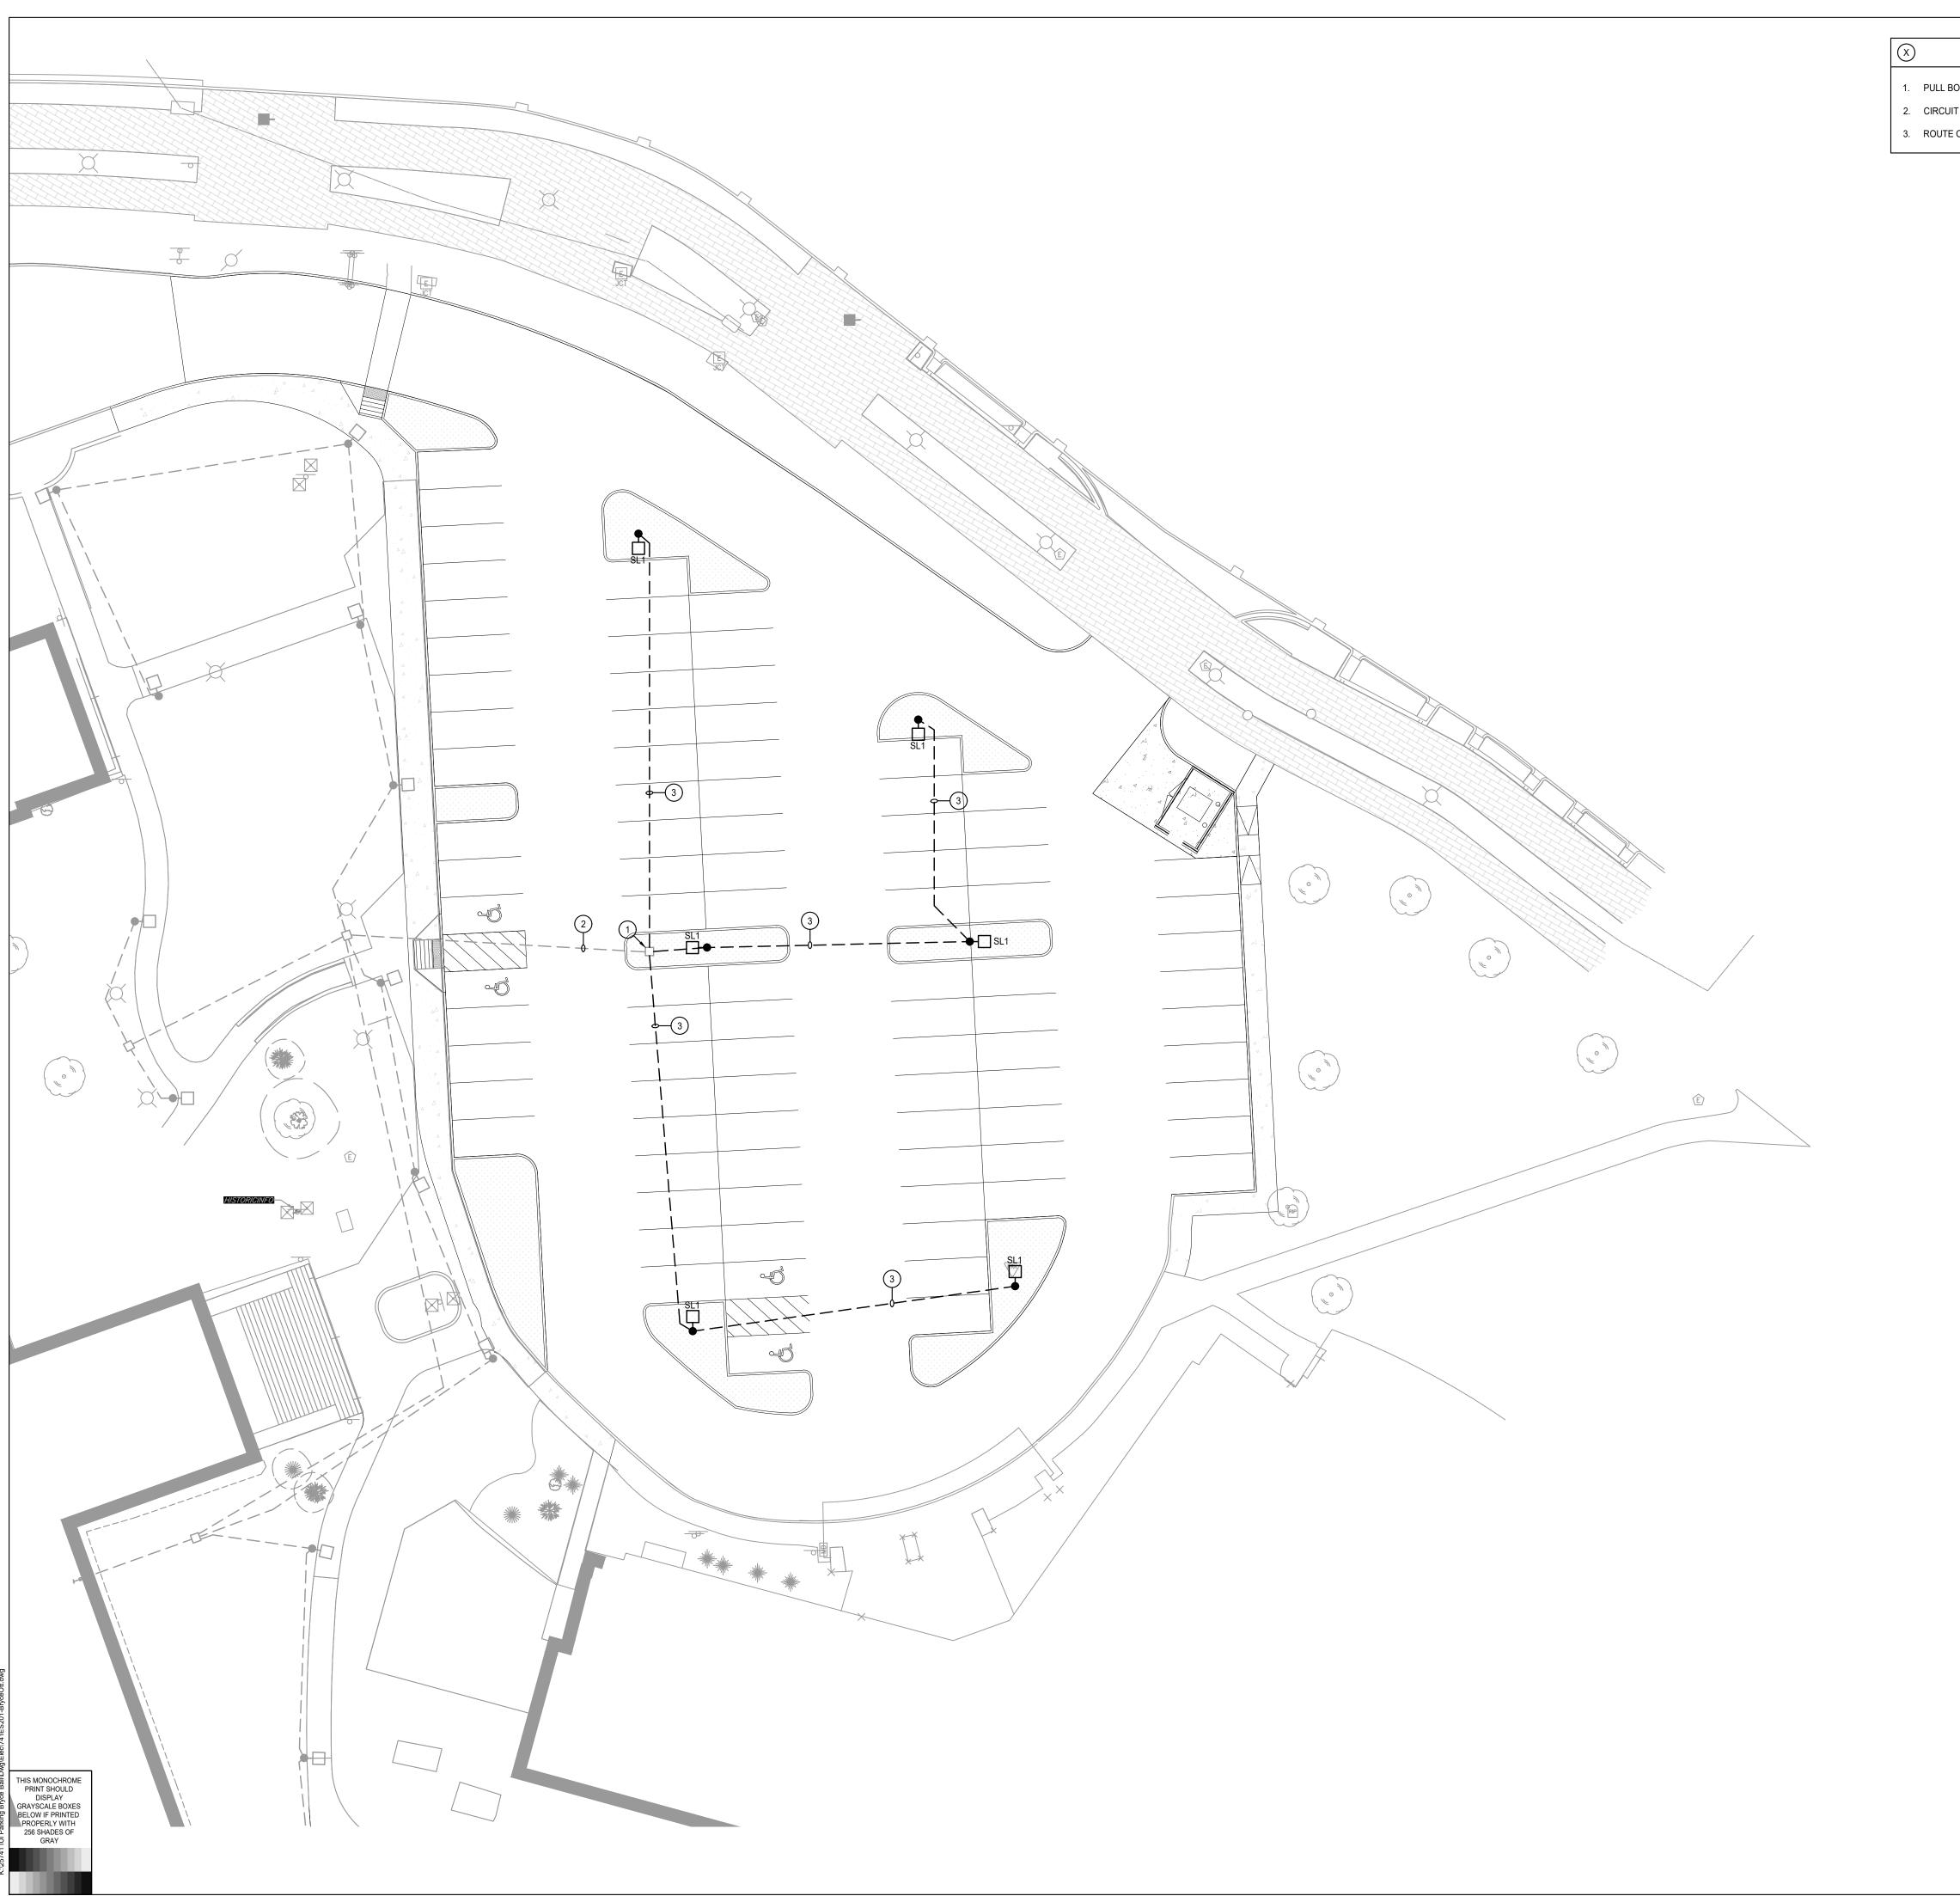

**PLAN NOTES** 

- 1. PULL BOX INSTALLED PER IU #20230562 PROJECT DOCUMENTS.
- 2. CIRCUIT 1LN1-56 IN HDPE CONDUIT WITH 2-#8, 1-#8G INSTALLED PER IU #20230562 PROJECT DOCUMENTS.
- 3. ROUTE CIRCUIT 1LN1-56 IN ONE (1) 1" HDPE CONDUIT WITH 2-#8, 1-#8G.

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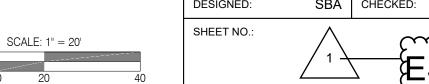
NO. 20240389

| Revision    | Date     |
|-------------|----------|
| Addendum #1 | 5/9/2025 |
|             |          |

PROJECT NO.:


SHEET NAME:
ELECTRICAL SITE PLAN

05/09/2025 SHEET ISSUE DATE: SBA CHECKED:



# 20240389 INDIANA UNIVERSITY INDIANAPOLIS - BALL HALL PARKING LOT IMPROVEMENTS

1226 W MICHIGAN ST INDIANAPOLIS, 46202

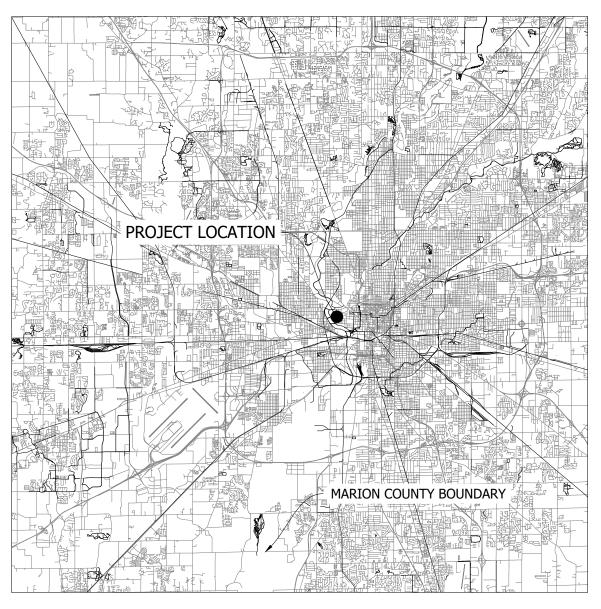

COUNTY LOCATION MAP SCALE: 1" = 20,000'

#### PROJECT LOCATION


PROJECT IS LOCATED TO THE NORTH OF W MICHIGAN STREET WITH THE NEAREST LARGE INTERSECTION AS N WEST STREET AND W MICHIGAN STREET.

#### USGS REFERENCED BENCHMARK


#### GENERAL COORDINATES: 39° N & 86°

SEC. 2-15-3: IN INDIANAPOLIS, AT 902 WEST NEW YORK STREET, IN THE NORTHWEST CORNER OF A PLANTER AT THE NUMBER 5 ENTRANCE ON THE NORTH SIDE OF THE EDUCATION-SOCIAL WORK BUILDING, 25.5 M (83.7 FT) WEST OF THE CORNER NORTH BLAKE STREET, 13.1 M (43.0 FT) NORTH OF THE CENTER OF THE WEST 1 OF 3 DOORS OF THE ENTRANCE, 5.9 M (19.4 FT) EAST OF THE NORTH END OF A SET OF STEPS LEADING TO THE SECOND FLOOR OF THE BUILDING, 2.7 M (8.9 FT) WEST OF THE WEST FACE OF THE BULDING, AND 0.2 M (0.7 FT) SOUTH OF THE SOUTH EDGE OF A SIDEWALK. NOTE-ACCESS TO DATUM POINT IS HAD THROUGH A 5-INCH LOGO CAP. THE MARK IS ABOVE LEVEL WITH SIDEWALK.

ELEV. 704.16

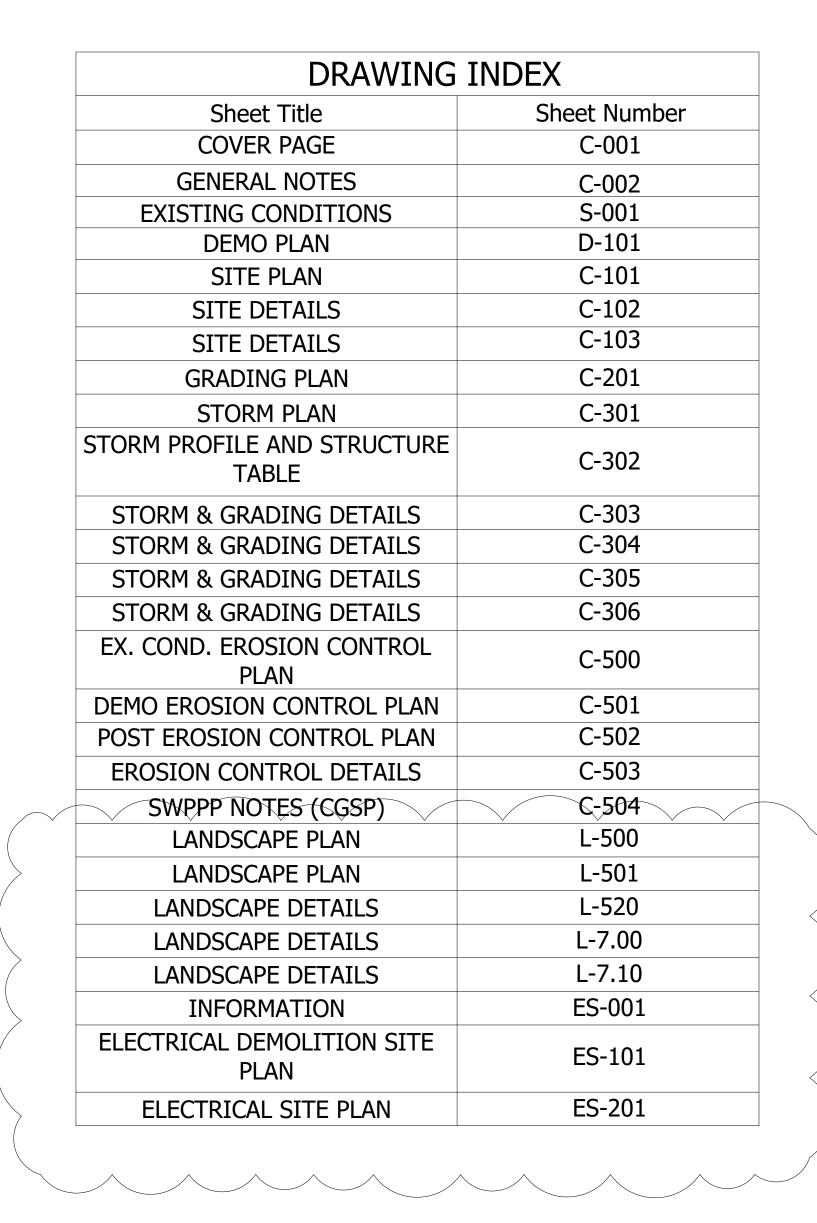

INDIANAPOLIS DEPARTMENT OF BUSINESS AND NEIGHBORHOOD SERVICES, (BNS), CITY-COUNTY BUILDING 200 E. WASHINGTON STREET, SUITE 107 INDIANAPOLIS, IN 46204 317-327-8700 FINAL PLANS APPROVED , 2024

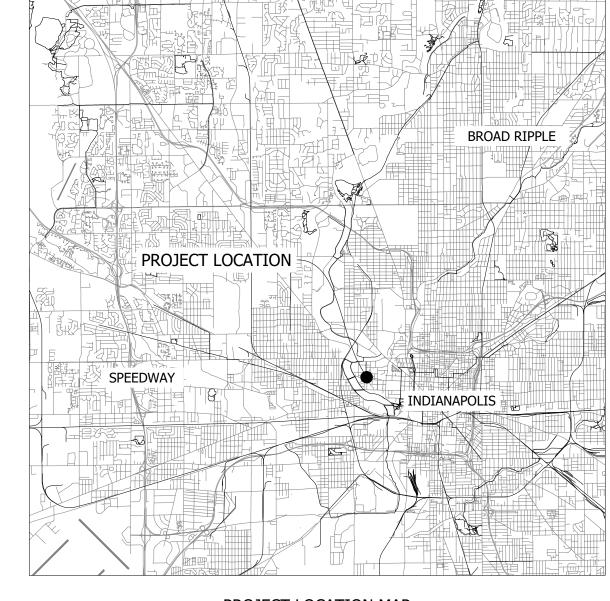

PROJECT LOCATION MAP SCALE: 1" = 10,000'

# PROJECT LOCATION W MICHIGAN ST. W MREZ Z

VICINITY MAP SCALE: 1" = 2,000'

#### STORM SEWER INVENTORY

| STRUCTURE / PIPE     | QUANTITY |
|----------------------|----------|
| RCP, 12-IN.          | 374 LF   |
| RCP, 15-IN           | 124 EACH |
| RCP, 18-IN           | 76 EACH  |
| RCP, 24-IN           | 44 LF    |
| INDOT MANHOLE TYPE C | 4 EACH   |
| INDOT INLET TYPE A   | 7 EACH   |
|                      |          |

#### QUANTITIES NOTE:

ANY AND ALL QUANTITY TABLES, NOTES OR VALUES AS SHOWN ON THESE PLANS ARE FOR REFERENCE ONLY. THE PLANS, DETAILS, AND SPECIFICATIONS GOVERN. IT IS THE RESPONSIBILITY OF THE CONTRACTOR TO REVIEW THE ENTIRE CONSTRUCTION SET AND DETERMINE ALL THE FINAL QUANTITIES FOR ALL NECESSARY ITEMS REQUIRED TO COMPLETE THIS PROJECT. THE OWNER OR THE ENGINEER WILL NOT BE HELD LIABLE OR RESPONSIBLE FOR ESTIMATES NOT CONFIRMED BY THE CONTRACTORS. THE CONTRACTOR SHALL VERIFY ALL QUANTITIES PRIOR TO BIDDING AND CONSTRUCTION. IF DISCREPANCIES ARE FOUND, CONTACT THE ENGINEER IMMEDIATELY.

#### WATER QUALITY BMP INFORMATION

| TYPE                           | STATE PLANE COORDINAT |              |  |  |  |  |  |  |
|--------------------------------|-----------------------|--------------|--|--|--|--|--|--|
|                                | X (EAST)              | Y (NORTH)    |  |  |  |  |  |  |
| UNDERGROUND DETENTION          | 182907.1325           | 1649281.3060 |  |  |  |  |  |  |
| STORMTRAP STORMSETTLER, SSET-5 | 182934.5731           | 1649284.4766 |  |  |  |  |  |  |





2901 E. DISCOVERY PARKWAY


BLOOMINGTON, IN 47408

JQOL QUALITY OF LIFE 8440 ALLISON POINTE BLVD, INDIANAPOLIS, IN 46250 HTTP://JQOLUSA.COM



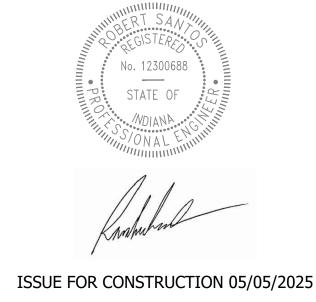

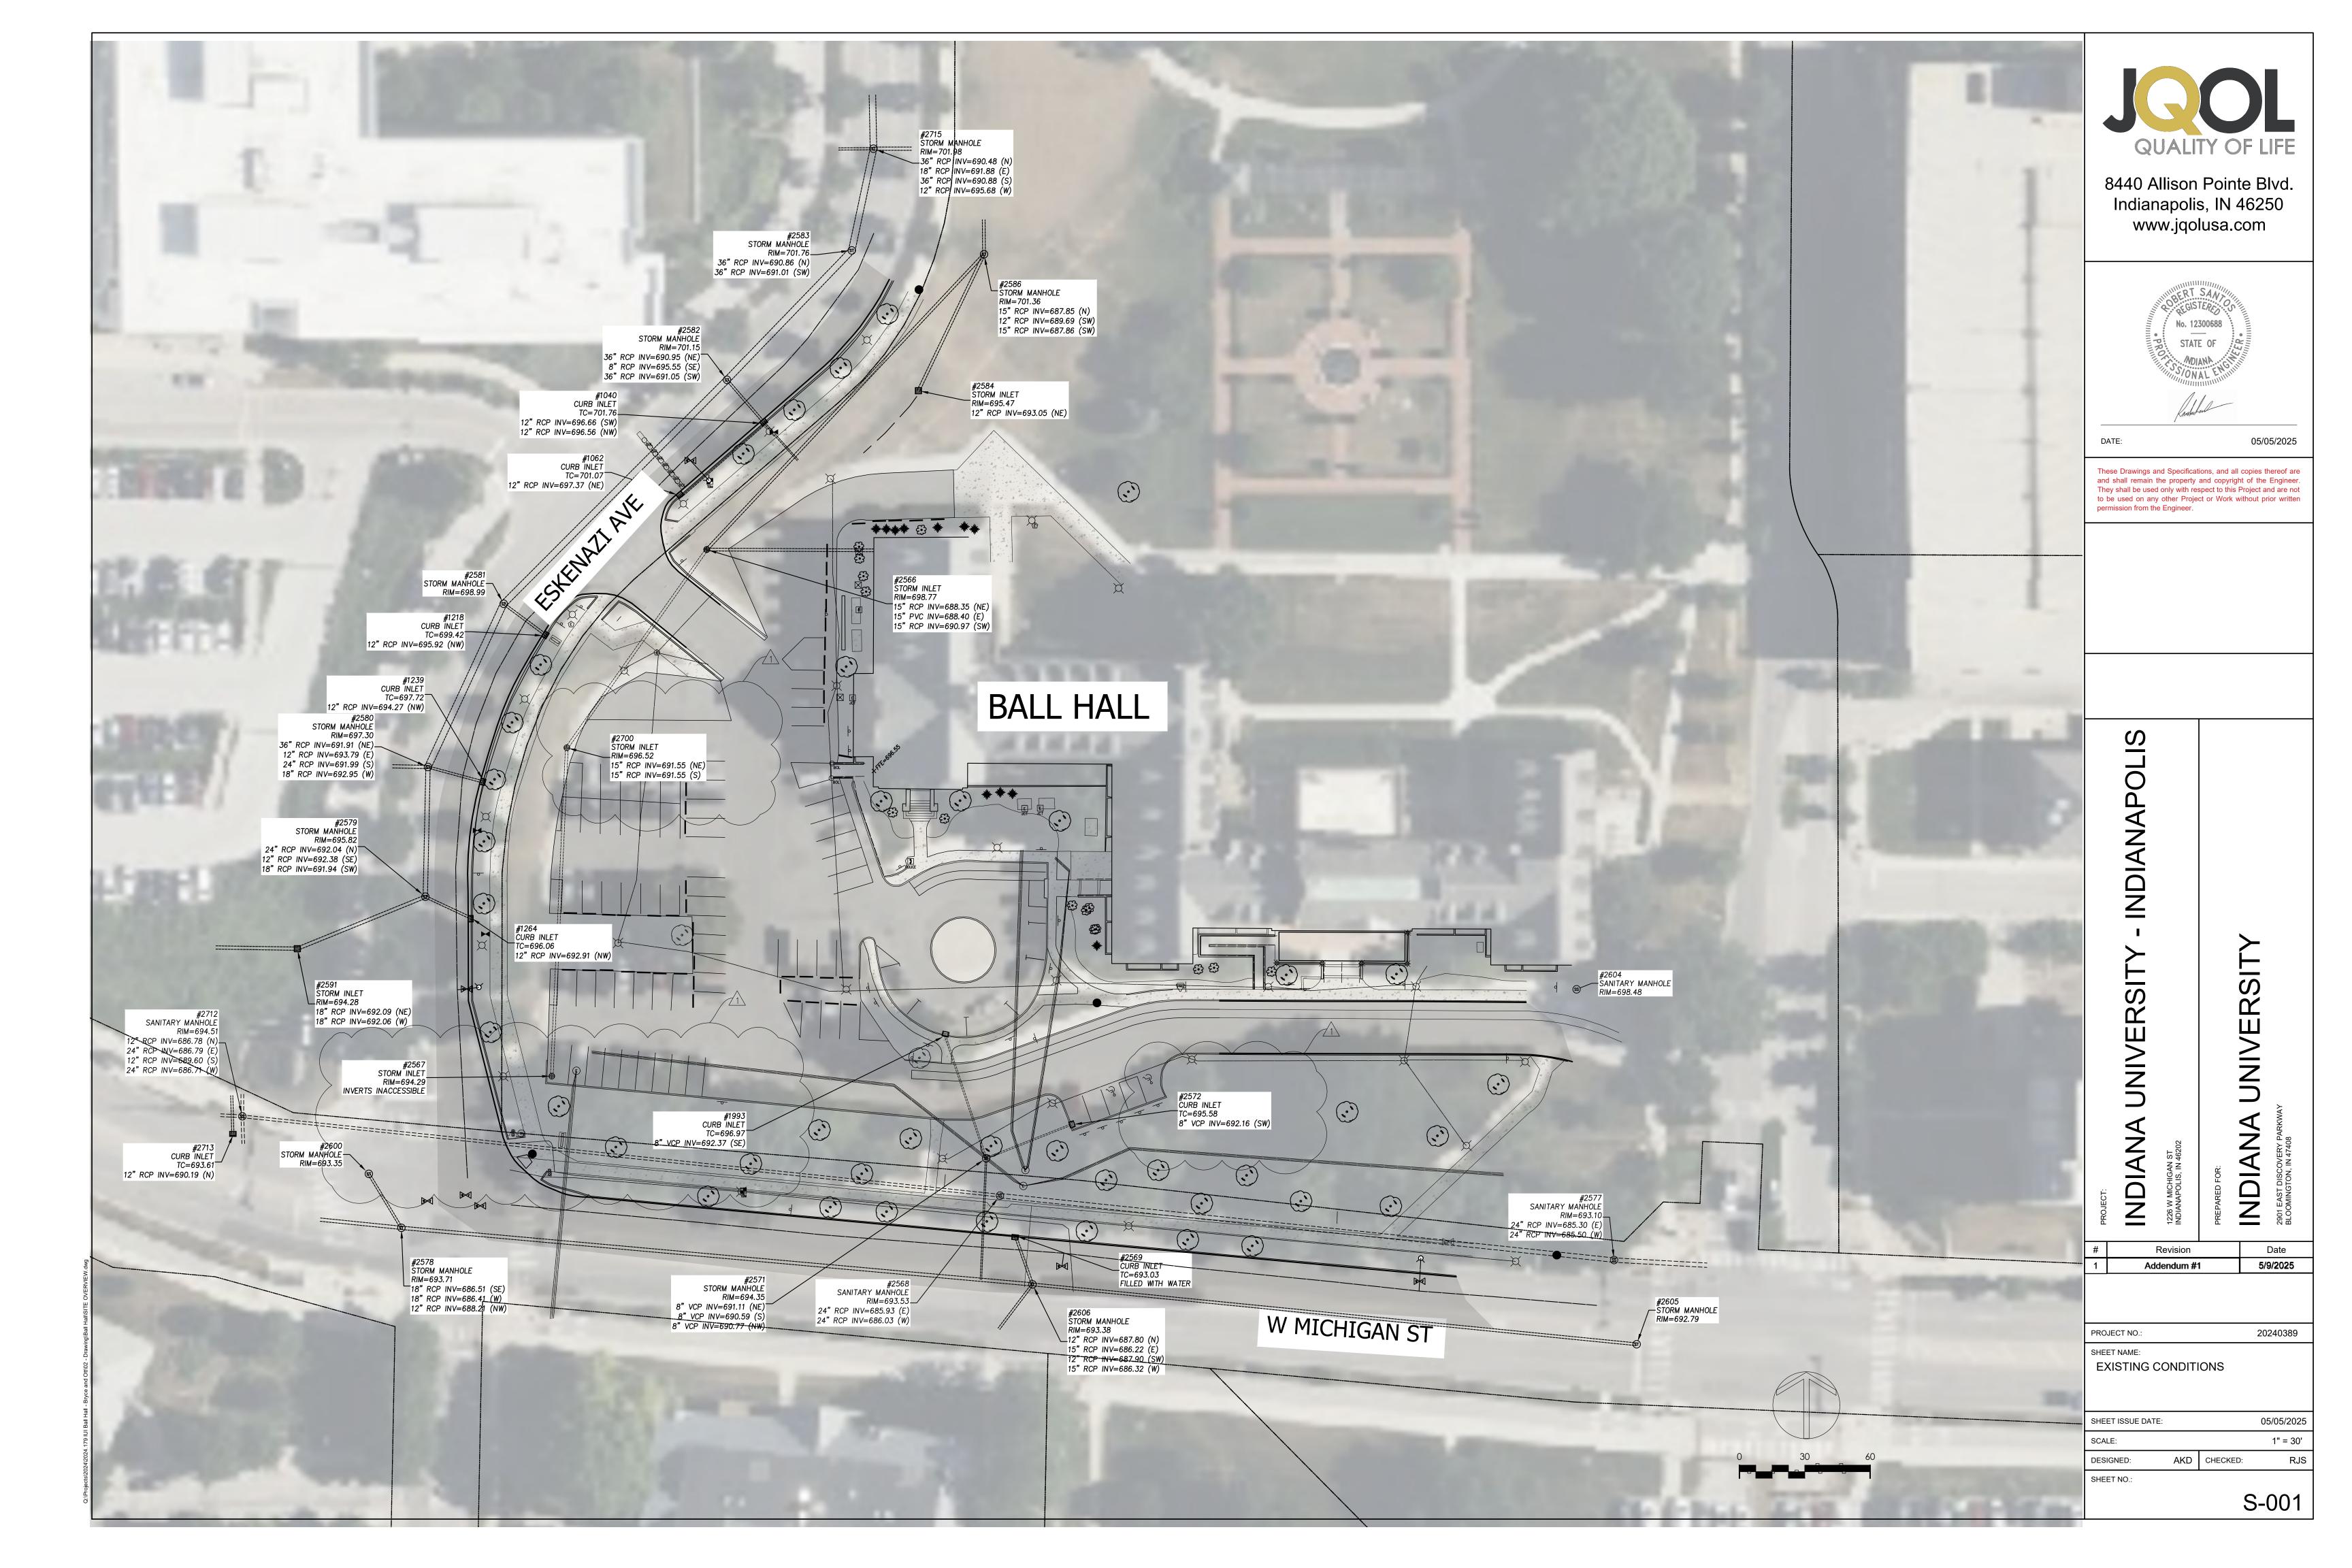

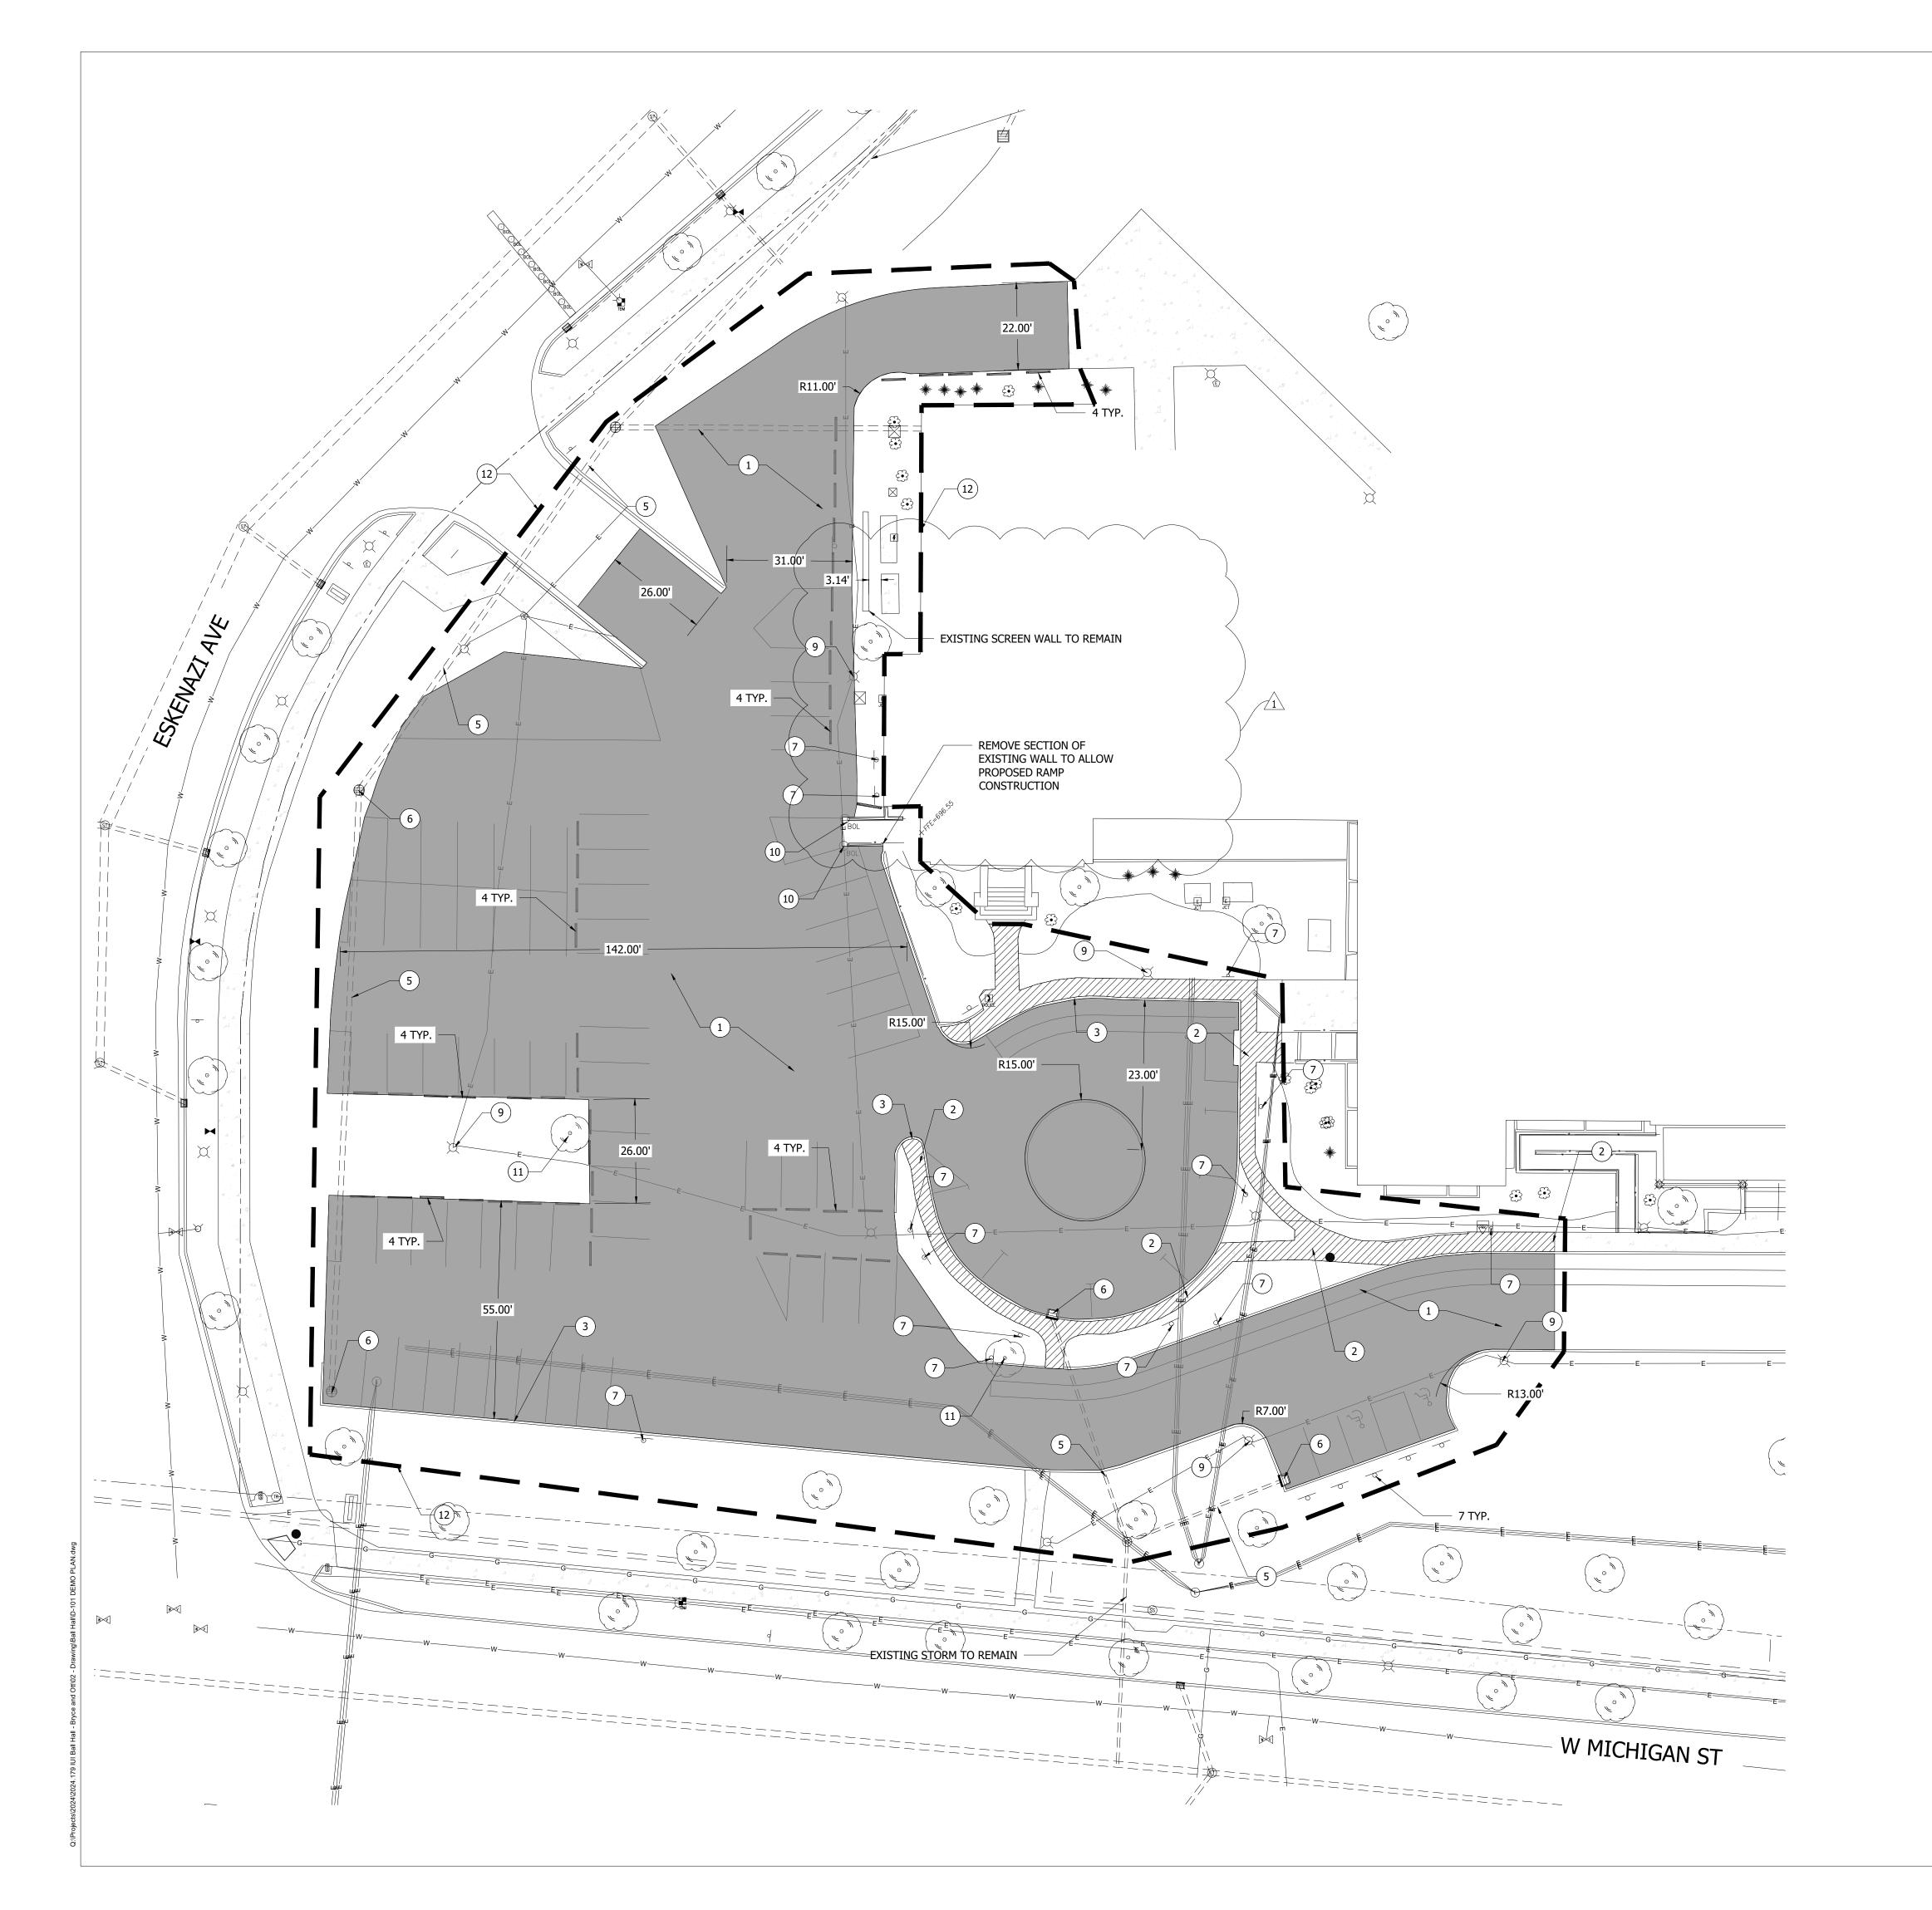

#### DEMOLITION PLAN KEYNOTES

- 1 PAVEMENT REMOVAL
- 2 REMOVE SIDEWALK



- 3 REMOVE CURB
- (4) REMOVE PARKING BUMPERS
- 5 REMOVE STORM PIPE
- 6 REMOVE STORM INLET
- 7 REMOVE SIGN
- 8 REMOVE STORM MANHOLE
- 9 REMOVE POWER STRUCTURE
- (10) REMOVE BOLLARD
- (11) REMOVE TREE
- 12 LIMITS OF DISTURBANCE

#### **GENERAL NOTES:**


CONTRACTOR SHALL VERIFY THE LOCATION OF UNDERGROUND UTILITIES PRIOR TO CONSTRUCTION.

CONTRACTOR SHALL MAINTAIN UTILITY SERVICE FOR DURATION OF CONSTRUCTION.

CONTRACTOR SHALL PROVIDE TEMPORARY SEEDING TO ALL DISTURBED AREAS WITHIN (7) DAYS OF COMPLETION OF WORK.



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DATE:
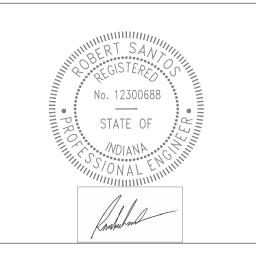
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05/05/2025

Date Revision 5/9/2025 Addendum #1

PROJECT NO.:

20240389 SHEET NAME: D-101 DEMO PLAN


AKD CHECKED:


| ® |                   |      |
|---|-------------------|------|
|   | SHEET ISSUE DATE: | 05/0 |
|   | SCALE:            | #### |
|   |                   |      |

DESIGNED:

SHEET NO.:

D-101

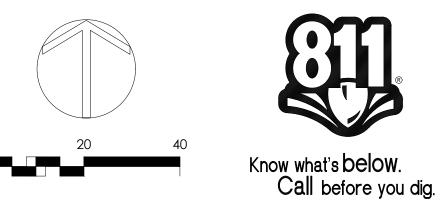

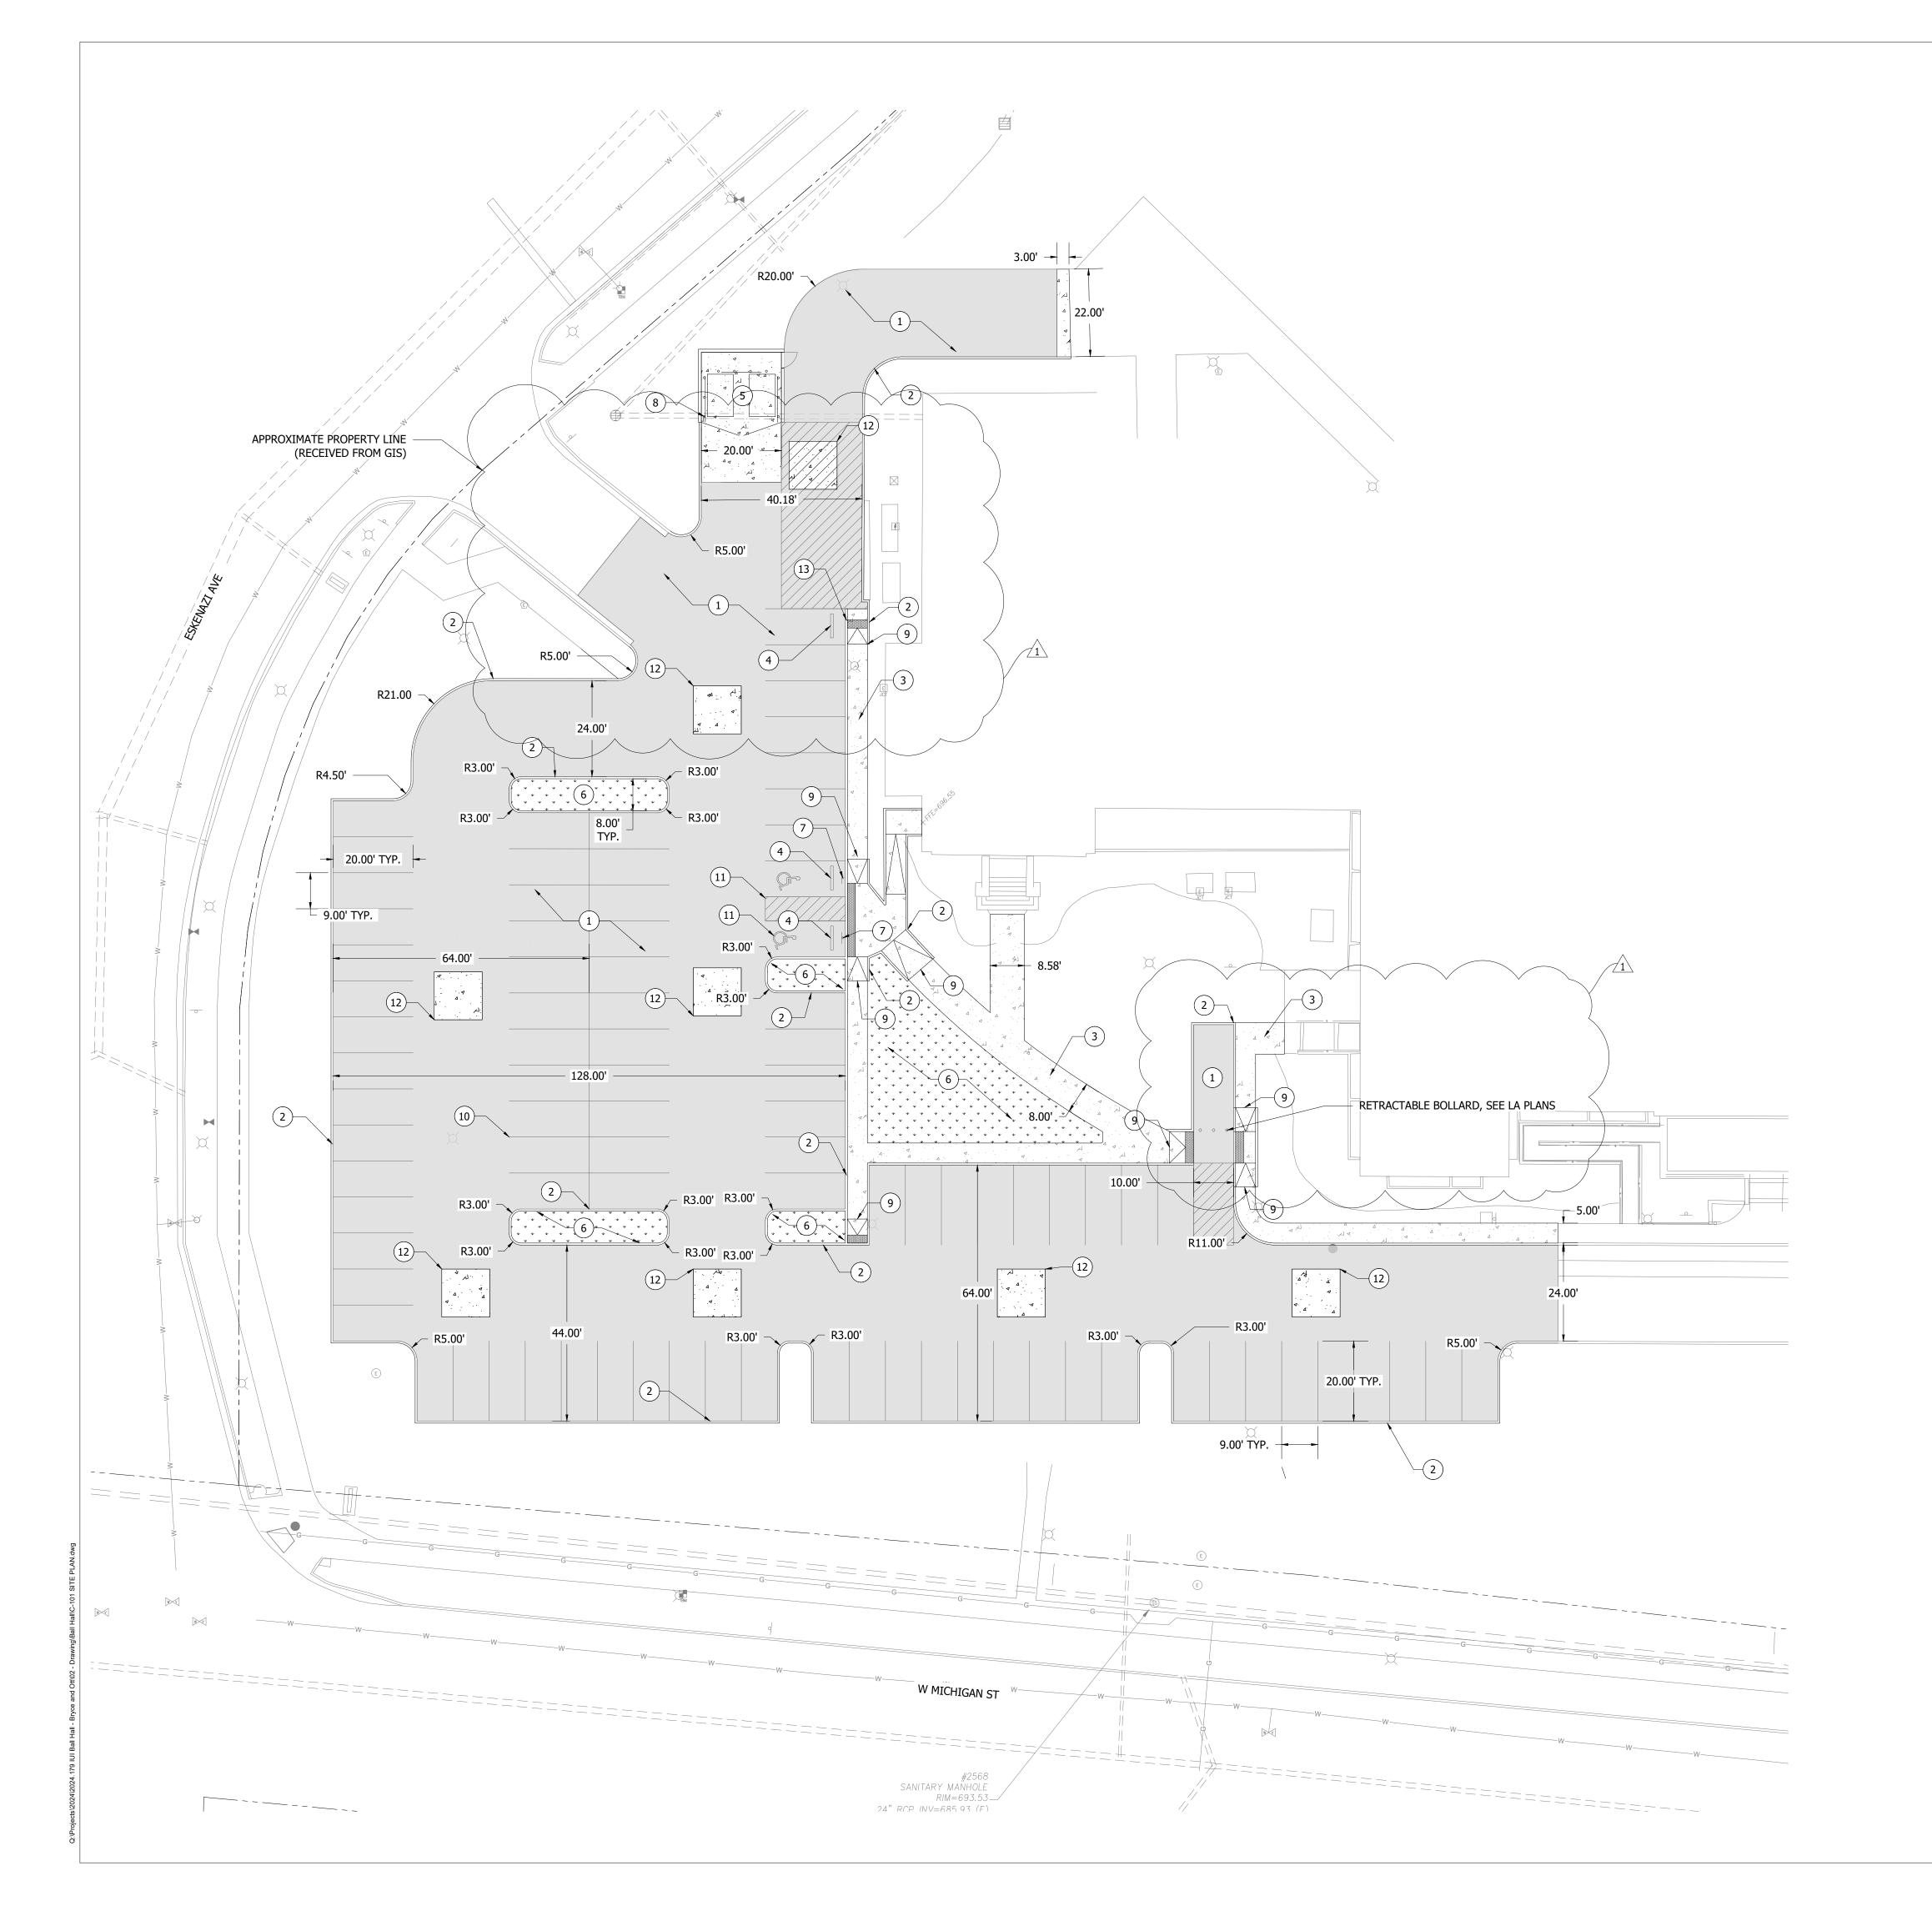


#### SITE PLAN KEYNOTES

- 1 FULL DEPTH HMA PAVEMENT, SEE SITE DETAIL ON SHEET C-102
- 2 CONCRETE CURB, SEE SITE DETAIL ON SHEET C-102
- 3 CONCRETE SIDEWALK, SEE SITE DETAIL ON SHEET C-102
- CONCRETE PARKING BUMPER (TYP.), SEE SITE DETAIL ON SHEET C-102
- 5 DUMPSTER ENCLOSURE, SEE SITE DETAIL ON SHEET C-103
- 6 LANDSCAPE AREA, REFER TO LANDSCAPE PLANS
- 7 ADA SIGN, SEE DETAIL ON SHEET C-102
- 8 BOLLARDS (TYP.), SEE DETAIL ON SHEET C-102
- 9 CURB RAMP, SEE DETAILS ON SHEET C-103
- 10 4" WHITE PAVEMENT MARKINGS (TYP.)
- (11) 4" BLUE PAVEMENT MARKINGS (TYP.)
- (12) CONCRETE APRON, SEE DETAIL ON SHEET C-102
- 13) TAPER 6" CURB

| BRYCE & OTT PARK    | ING REQUIREMENTS |
|---------------------|------------------|
| EXISTING SPACES     | 67 SPACES        |
| EXISTING ADA SPACES | 4 SPACES         |
| PROPOSED SPACES     | 146 SPACES       |
| PROPOSED ADA SPACES | 2 SPACES         |
|                     |                  |



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# 100% CONSTRUCTION DOCUMENT

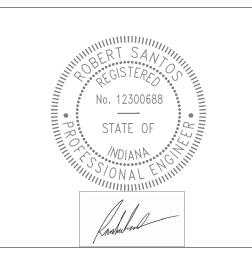UNIVERSITY - INDIANAPO

INDIANA AVENUE INDIANAPOLIS, IN 46202

Revision Date

Addendum #1 5/9/2025

PROJECT NO.: NO. 20240389

SHEET NAME:
SITE PLAN


SHEET NO.:

 SHEET ISSUE DATE:
 05/05/2025

 SCALE:
 1" = 20'

 DESIGNED:
 AKD
 CHECKED:
 RJS

C-101

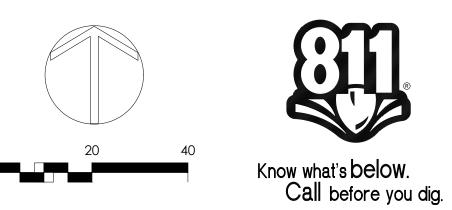





— — 700 — — — PROPOSED CONTOUR 851.75

MATCH EXISTING GRADE

LIMITS OF DISTURBANCE

ME 851.75

UNDERGROUND STORAGE



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Date Revision 5/9/2025 Addendum #1

PROJECT NO.:

Know what's below.


Call before you dig.


SHEET NAME: CG-101 GRADING PLAN

05/05/2025 SHEET ISSUE DATE: SCALE: 1" = 20' DESIGNED: AKD CHECKED: SHEET NO.:

C-201


20240389

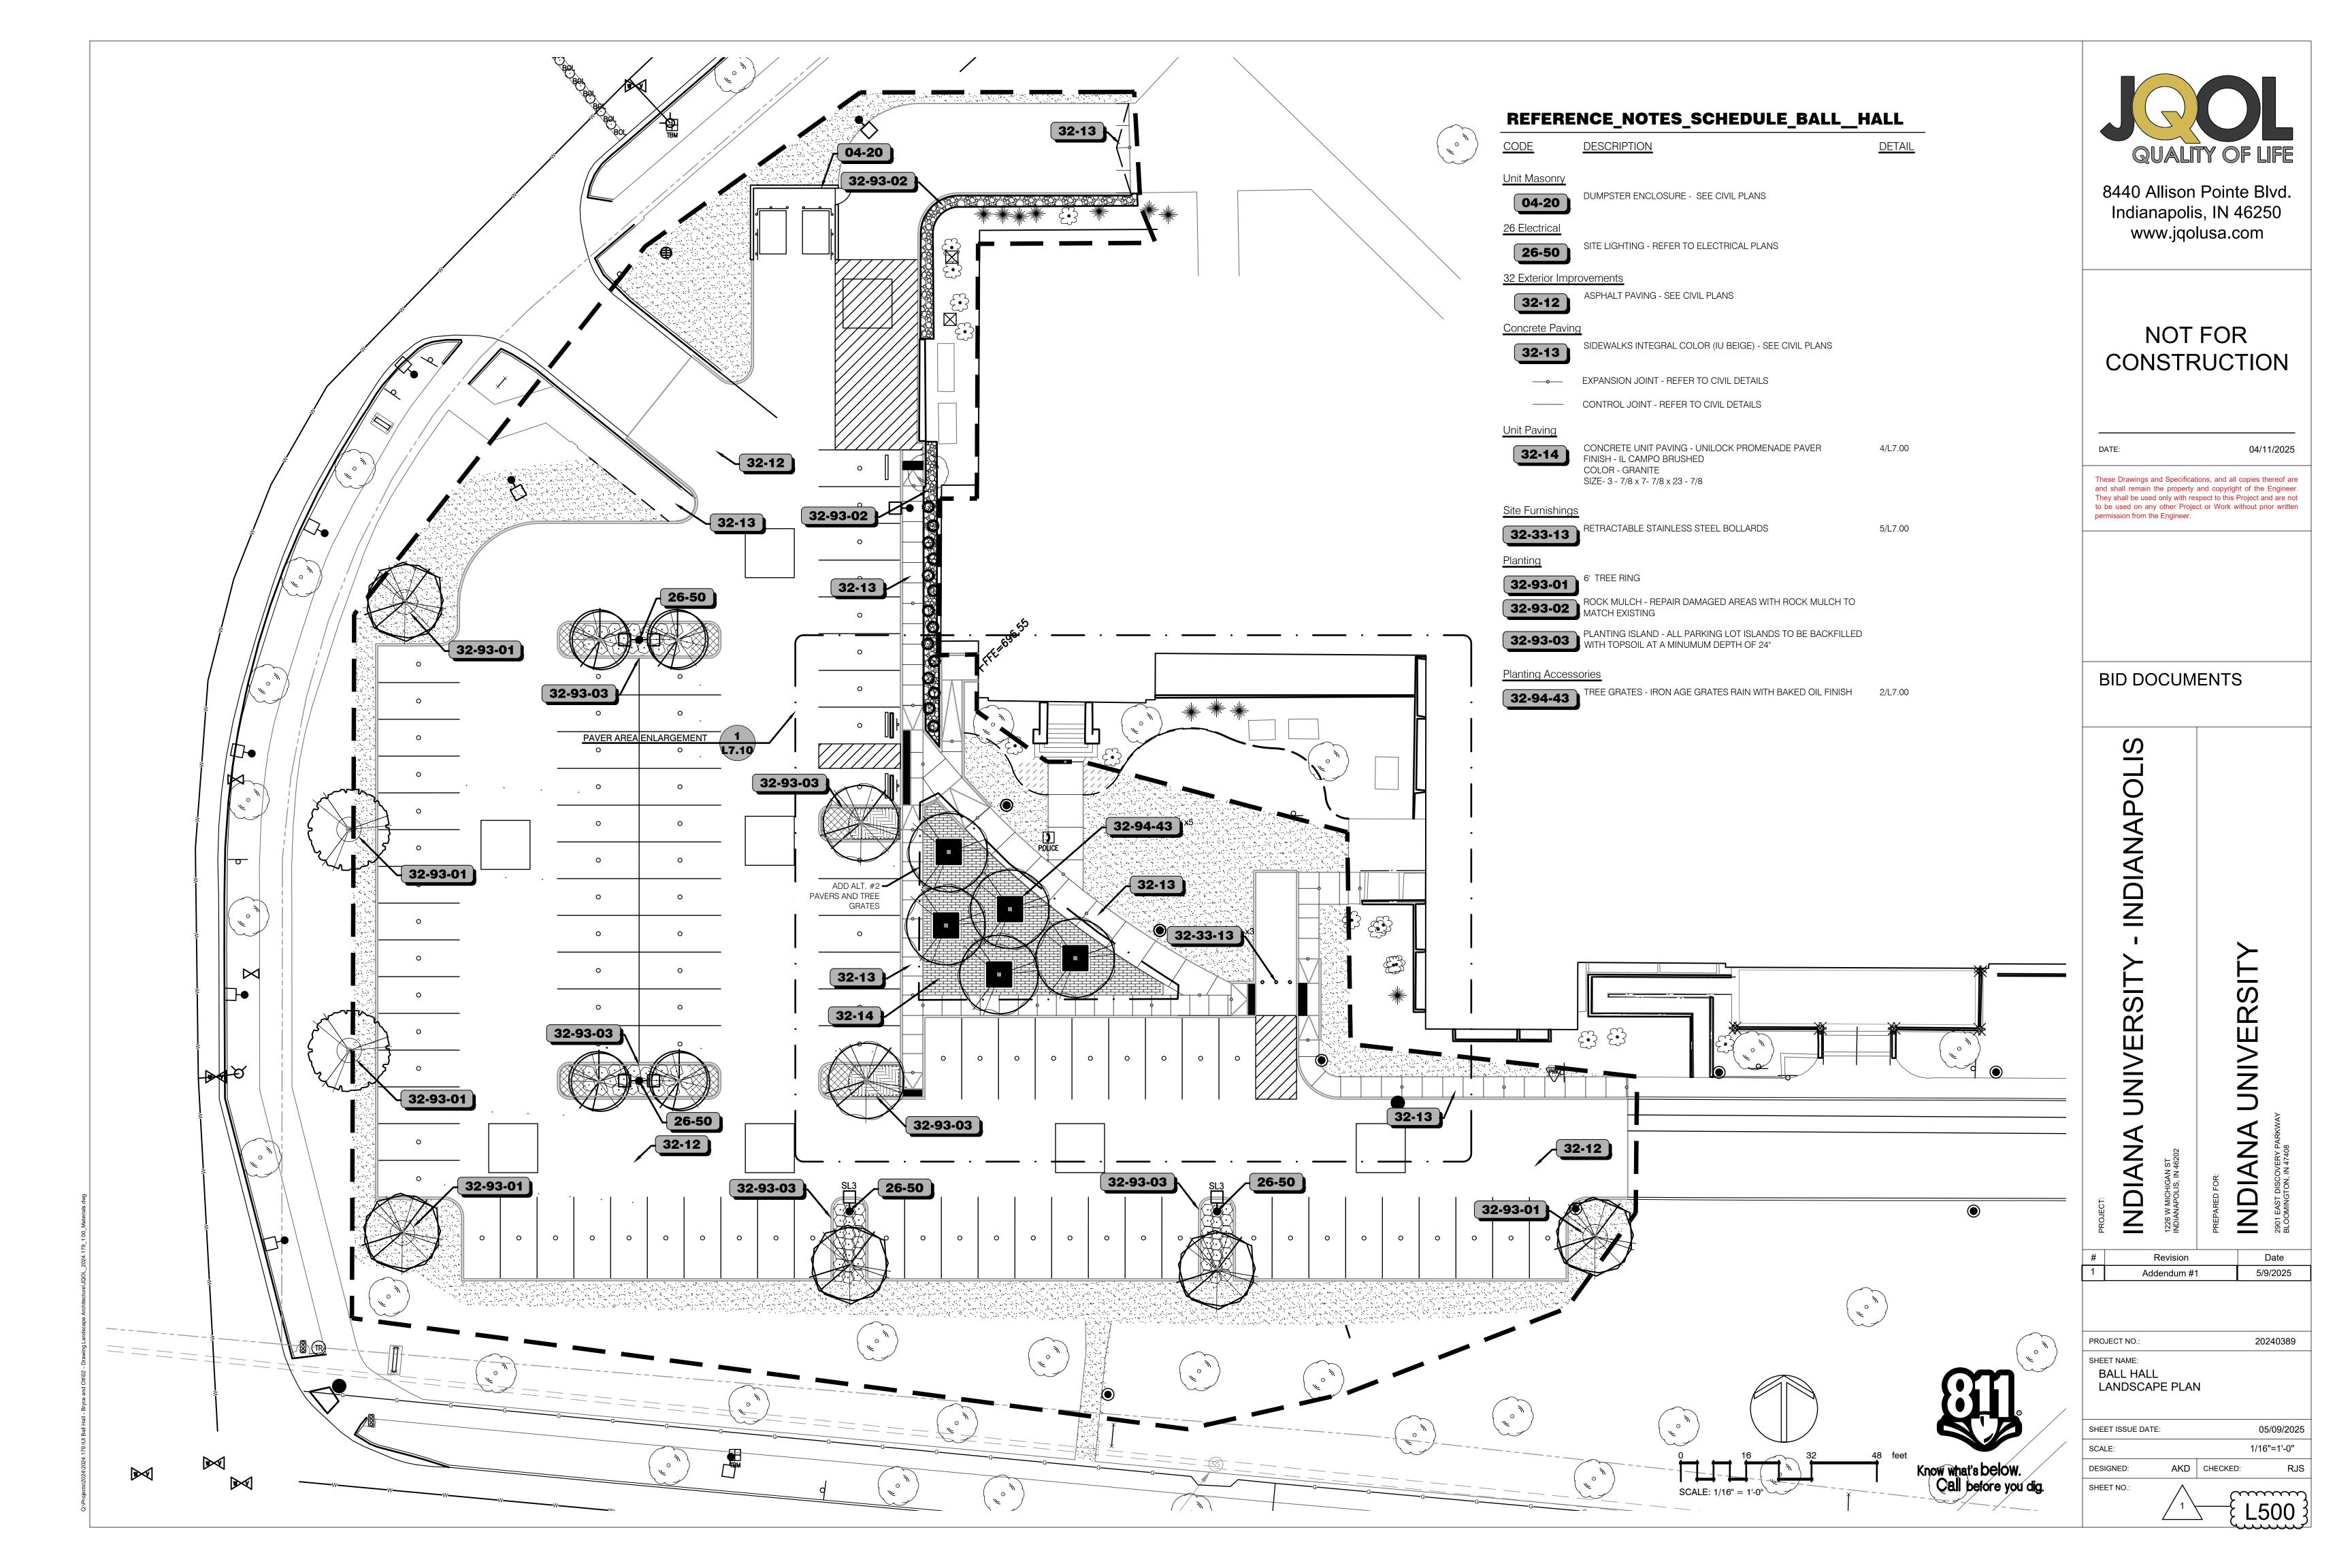

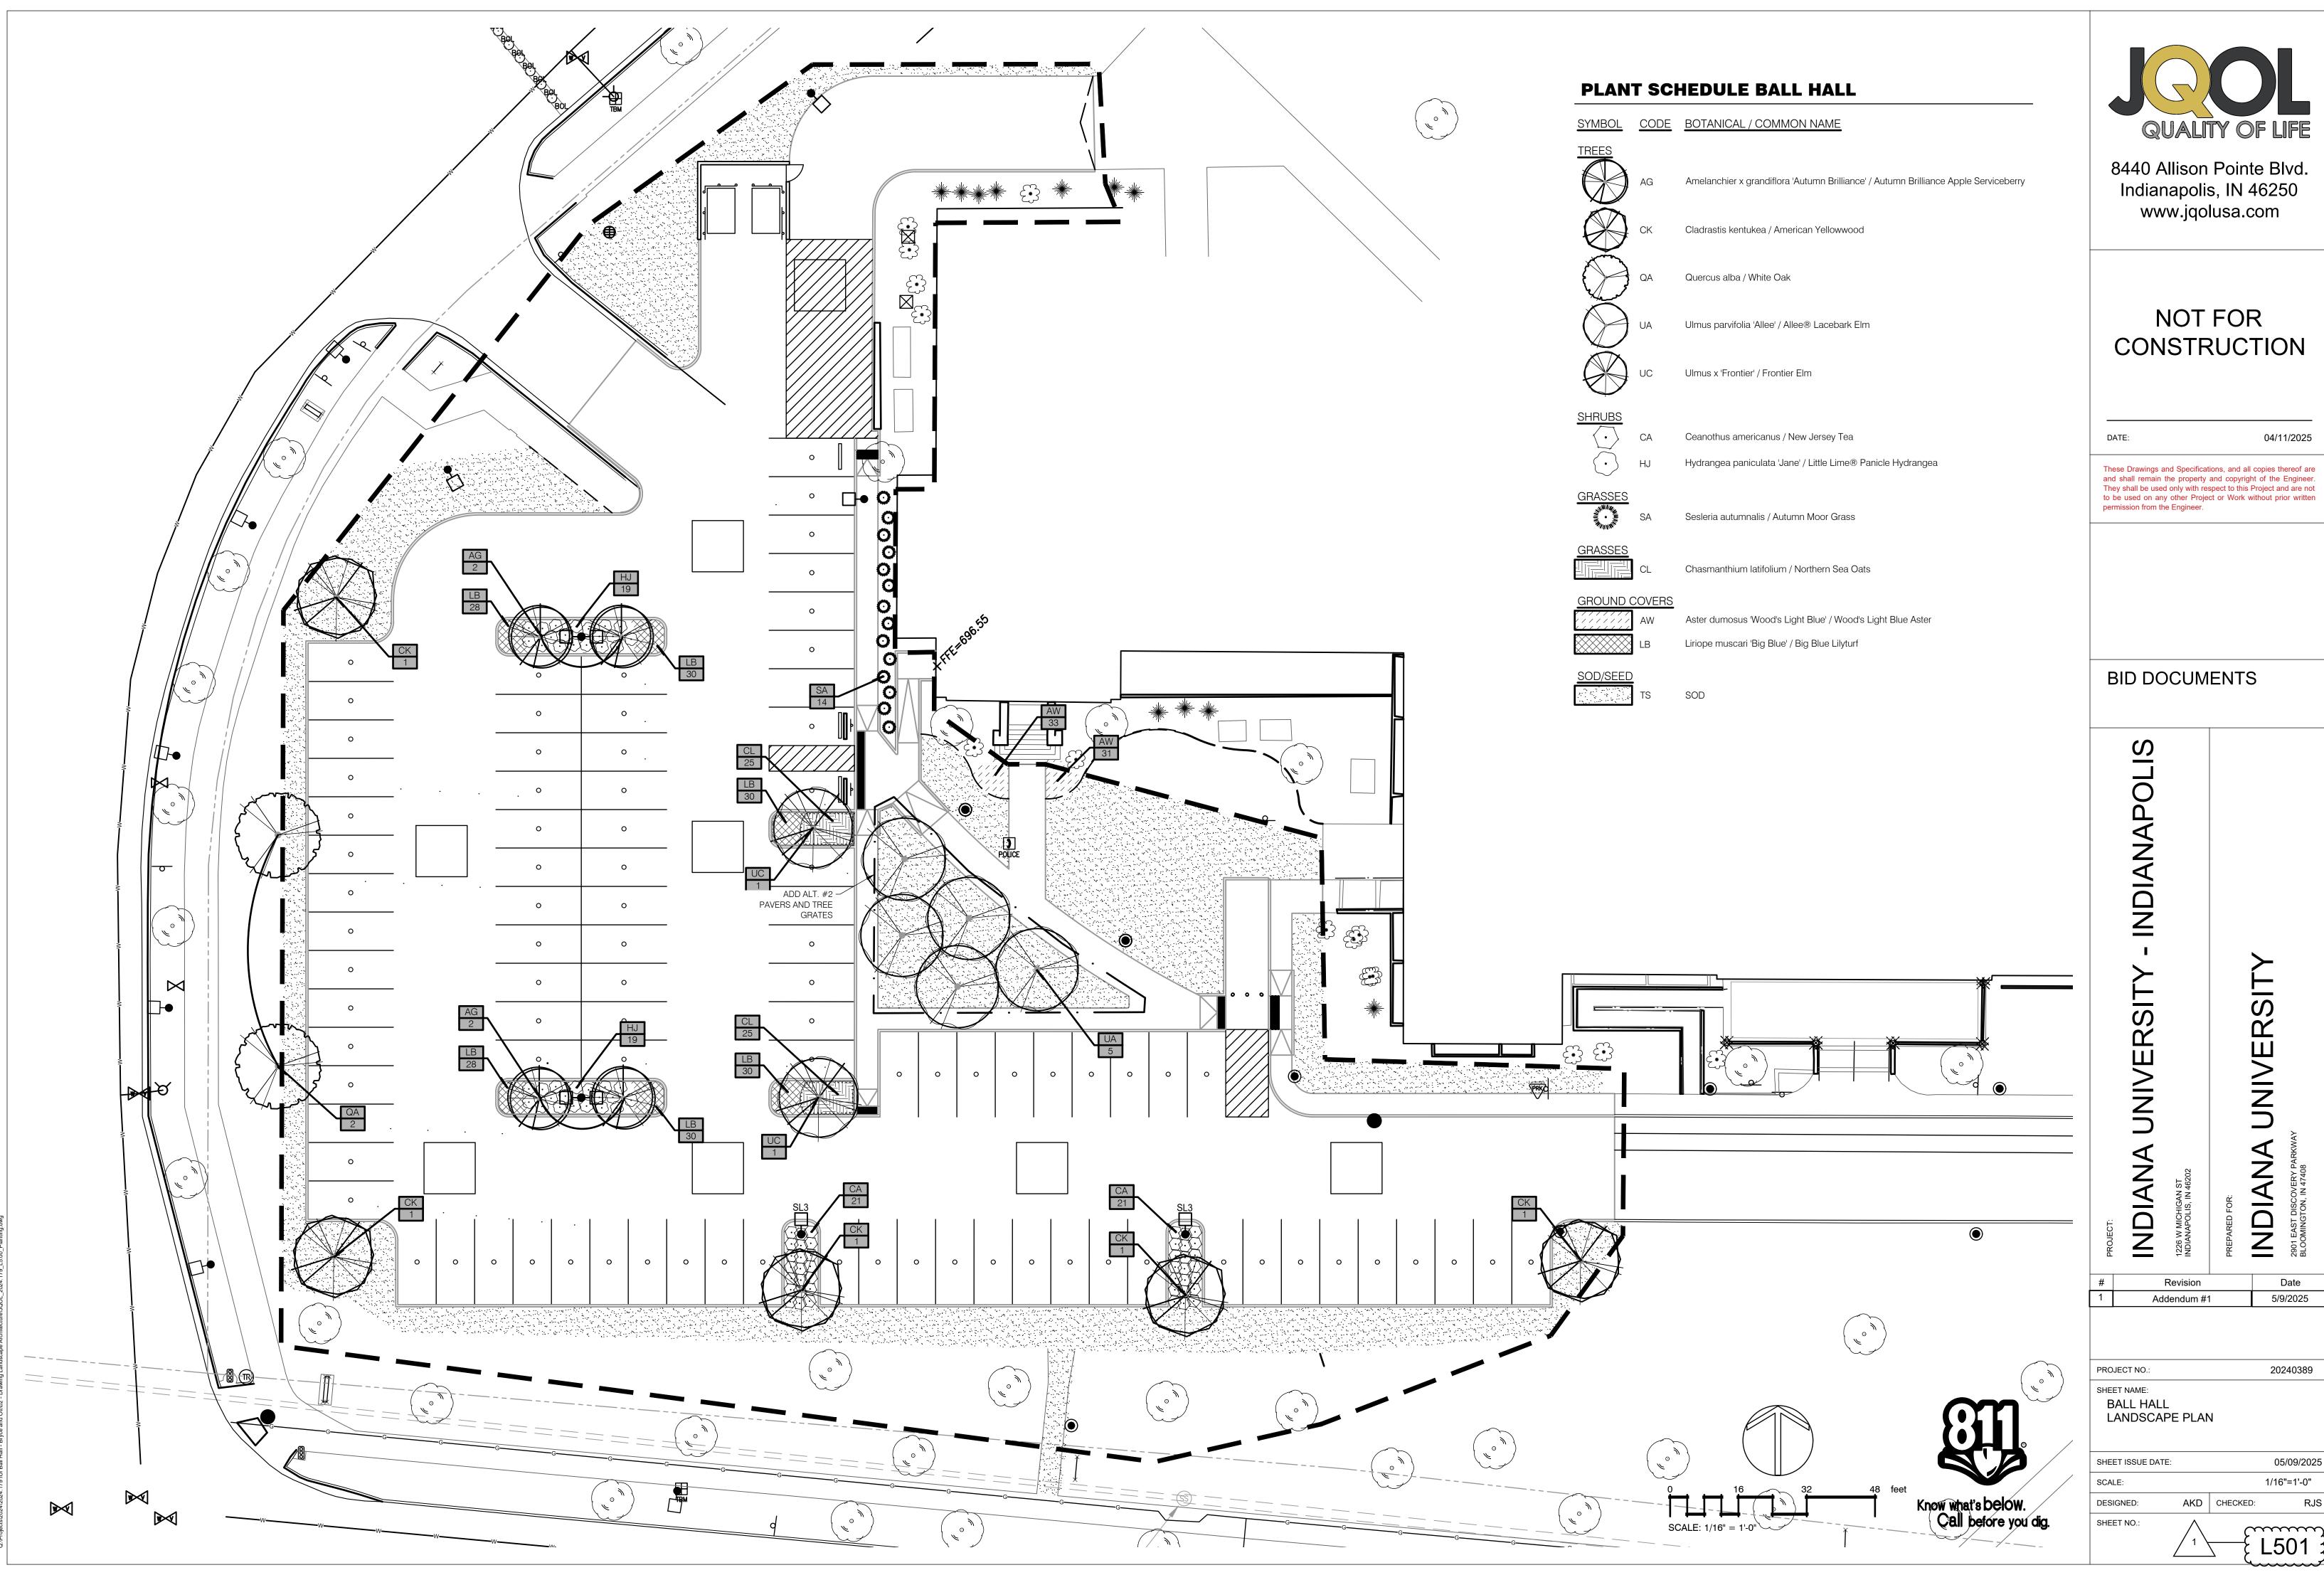



05/09/2025


| PLANT SCHEDULE BALL HALL |      |  |           |           |                |          |            |        |                             |  |
|--------------------------|------|--|-----------|-----------|----------------|----------|------------|--------|-----------------------------|--|
| SYMBOL                   | CODE | BOTANICAL / COMMON NAME  | SIZE      | CONTAINER |                |          | QTY        | DETAIL | REMARKS                     |  |
| TREES                    |      |  |           |           |                |          |            |        |                             |  |
|                          | AG   | Amelanchier x grandiflora 'Autumn Brilliance' / Autumn Brilliance Apple Serviceberry | 2" Cal.   | B&B       |                |          | 4          |        |                             |  |
|                          | CK   | Cladrastis kentukea / American Yellowwood  | 2.5" Cal. | B&B       |                |          | 5          |        |                             |  |
|                          | QA   | Quercus alba / White Oak   | 2.5" Cal. | B&B       |                |          | 2          |        |                             |  |
|                          | UA   | Ulmus parvifolia 'Allee' / Allee® Lacebark Elm                                       | 2.5" Cal. | B&B       |                |          | 5          |        |                             |  |
|                          | UC   | Ulmus x 'Frontier' / Frontier Elm  | 2.5" Cal. | B&B       |                |          | 2          |        |                             |  |
| SYMBOL                   | CODE | BOTANICAL / COMMON NAME  | SIZE      | CONTAINER | INSTALL HEIGHT |          | QTY        | DETAIL | REMARKS                     |  |
| SHRUBS •                 | CA   | Ceanothus americanus / New Jersey Tea  | 1 gal.    | Pot       | 18"            |          | 42         |        |                             |  |
|                          | HJ   | Hydrangea paniculata 'Jane' / Little Lime® Panicle Hydrangea                         | #3        | Pot       | 24"            |          | 38         |        |                             |  |
| GRASSES                  |      |  |           |           |                |          |            |        |                             |  |
|                          | SA   | Sesleria autumnalis / Autumn Moor Grass  | #3        | Pot       | 18"            |          | 14         |        |                             |  |
| SYMBOL                   | CODE | BOTANICAL / COMMON NAME  | SIZE      | CONTAINER | INSTALL HEIGHT | SPACING  | <u>QTY</u> | DETAIL | REMARKS                     |  |
| GRASSES                  | CL   | Chasmanthium latifolium / Northern Sea Oats  | #1        | Pot       | 18"            | 24" o.c. | 50         |        |                             |  |
| SYMBOL                   | CODE | BOTANICAL / COMMON NAME  | SIZE      | CONTAINER |                | SPACING  | QTY        | DETAIL | REMARKS                     |  |
| GROUND                   | 1    |  |           |           |                |          |            |        |                             |  |
| ·////////                | AW   | Aster dumosus 'Wood's Light Blue' / Wood's Light Blue Aster                          | #1        | Pot       |                | 16" o.c. | 64         |        |                             |  |
|                          | LB   | Liriope muscari 'Big Blue' / Big Blue Lilyturf                                       | #1        | Pot       |                | 16" o.c. | 176        |        |                             |  |
| SOD/SEED                 | TS   | SOD  | seed      |           |                |          | 10,901 sf  |        | TALL TURF TYPE FESCUE - SOD |  |
|                          |      |  |           |           |                |          |            |        |                             |  |

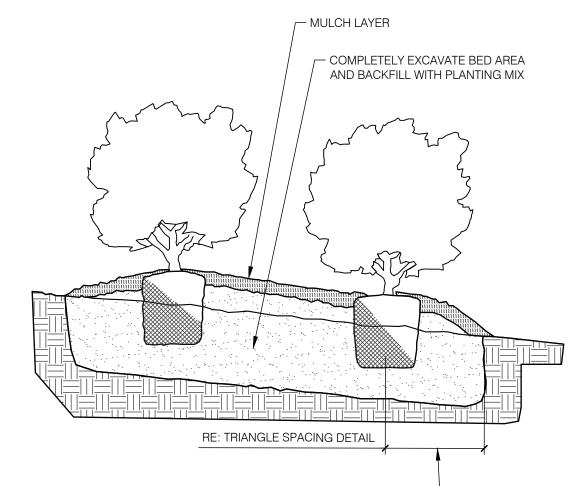



SHRUB/GROUNDCOVER PLANTING

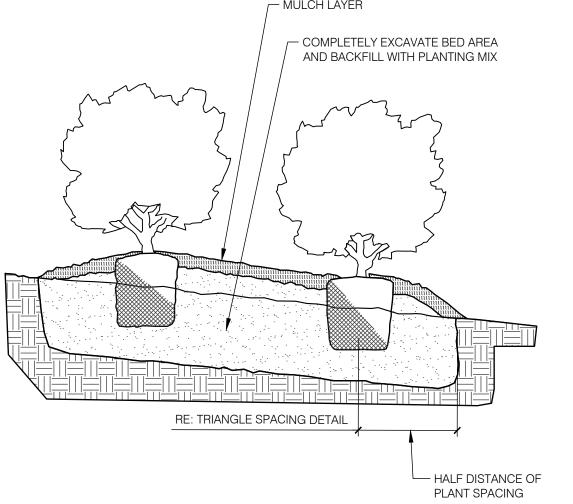


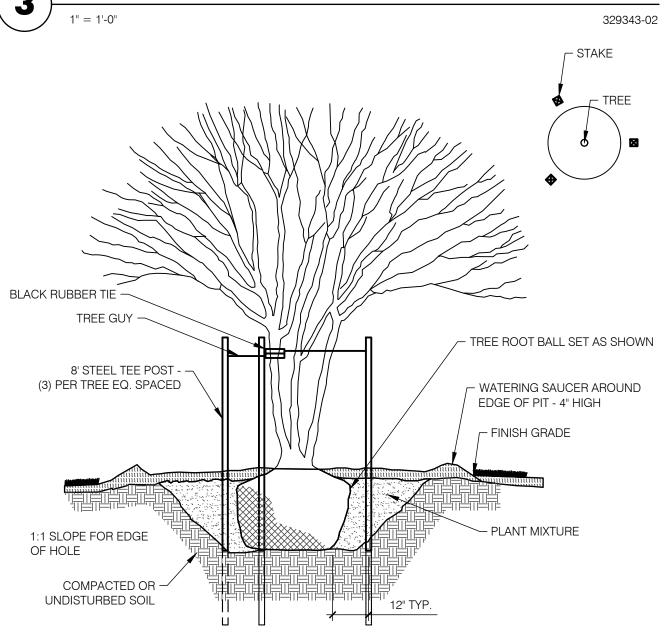

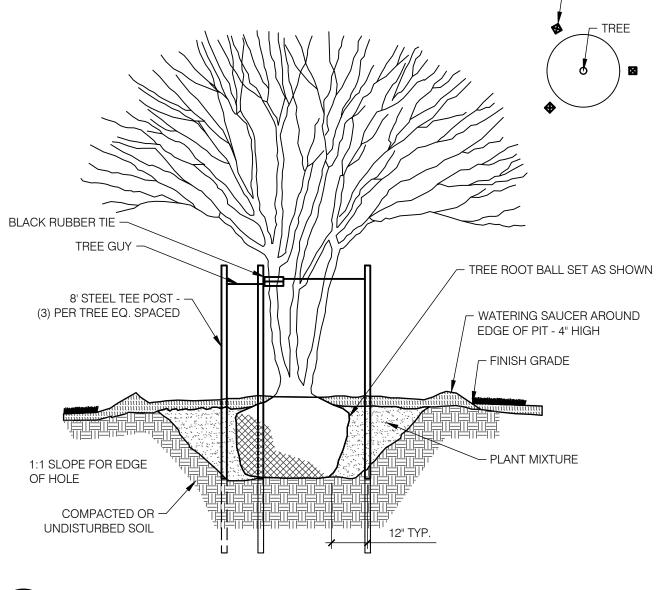

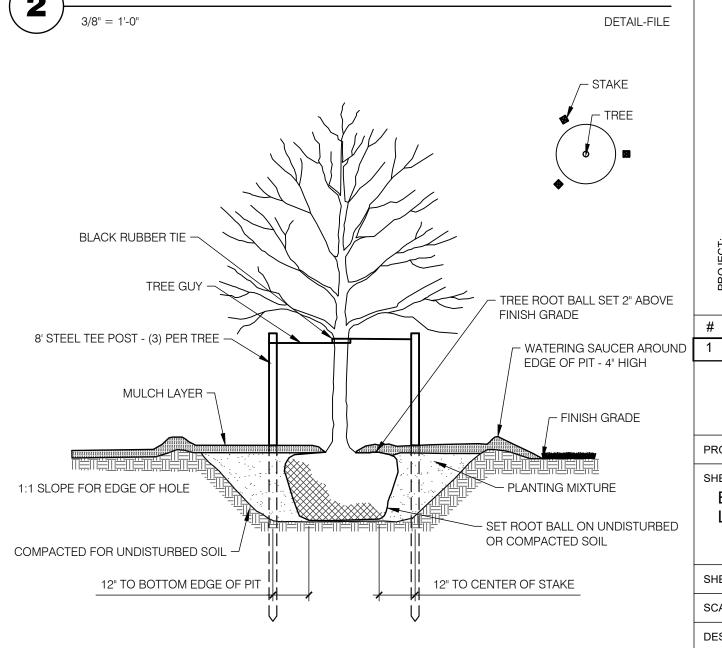

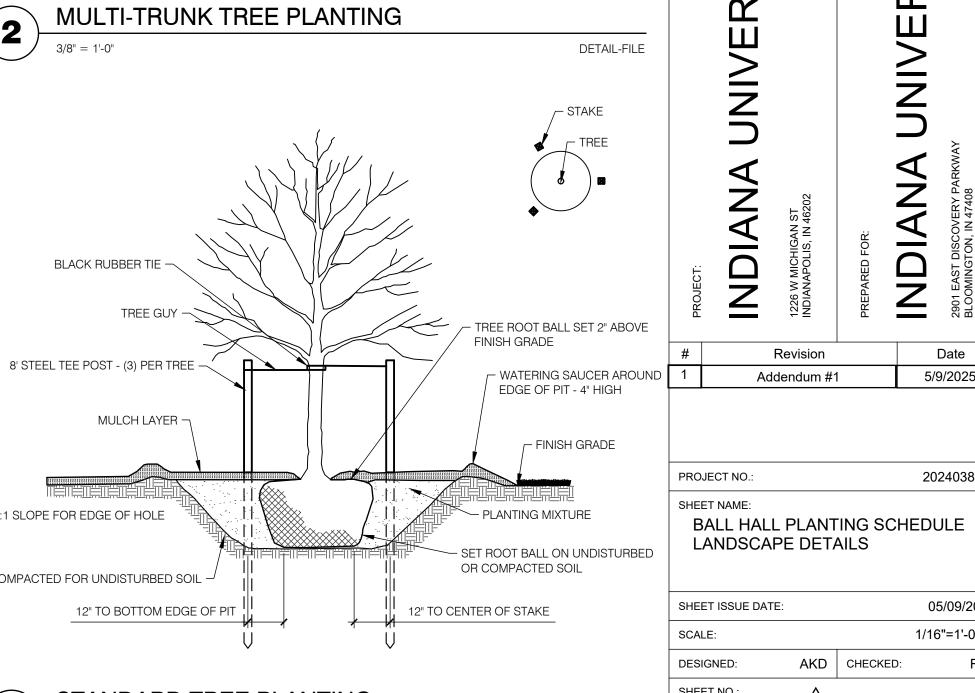

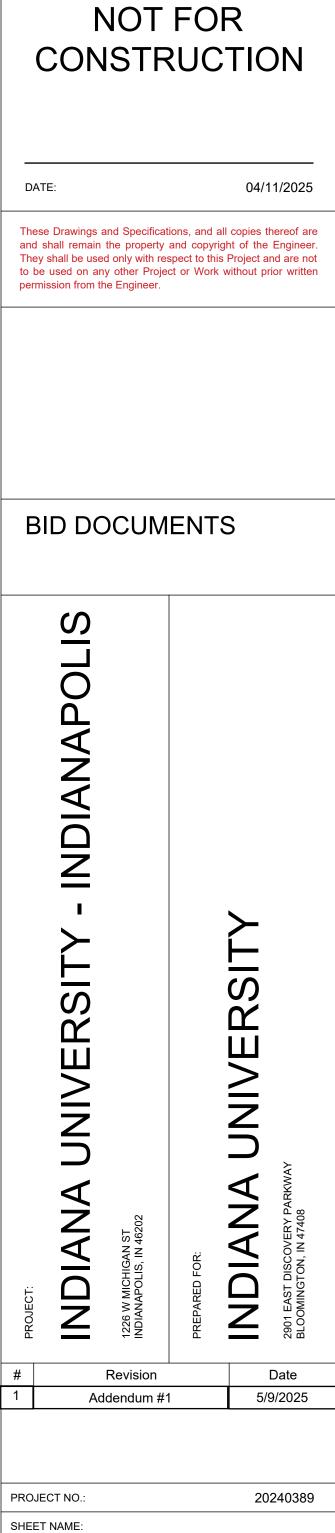

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SPACING AS NOTED ON PLANT LIST 6" FOR GROUNDCOVER 15" FOR SHRUBS PAVING EDGE/ BUILDING/CURB

- TYPICAL PLANT LOCATION

SPACING AS NOTED ON PLANT LIST

TRIANGULAR SPACING DIAGRAM

329343-05


STANDARD TREE PLANTING


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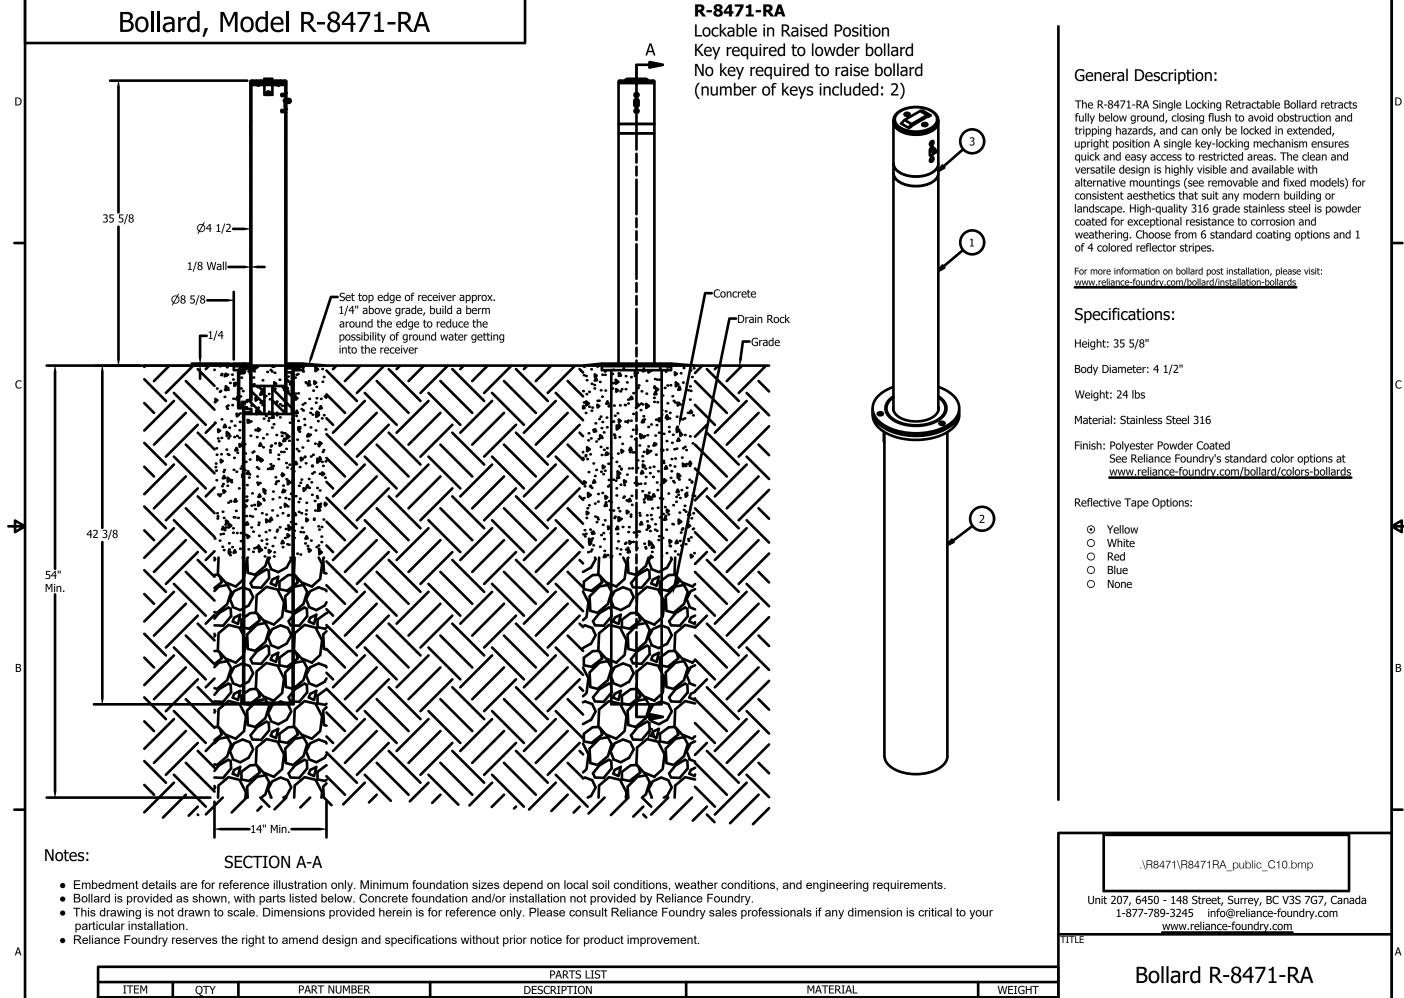
DETAIL-FILE

05/09/2025

1/16"=1'-0"



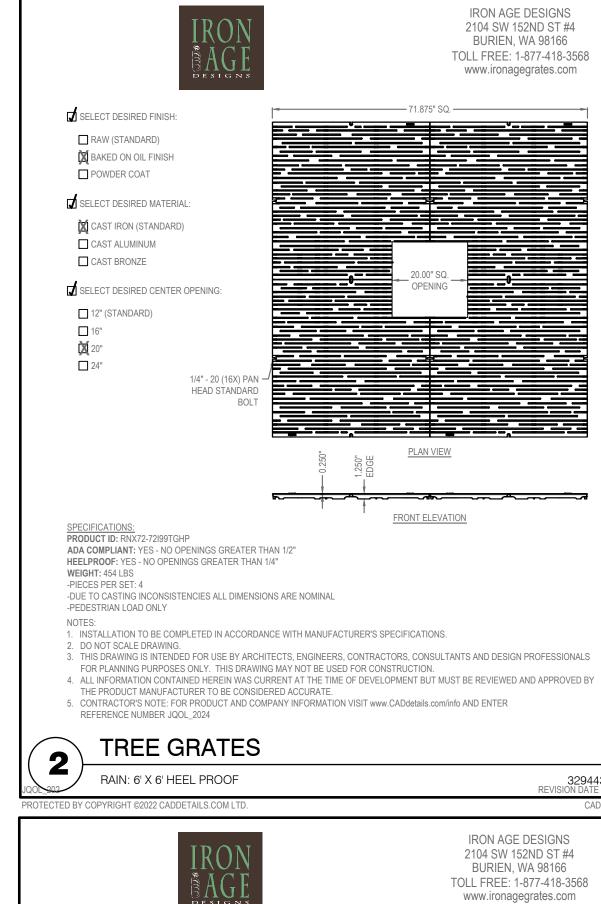

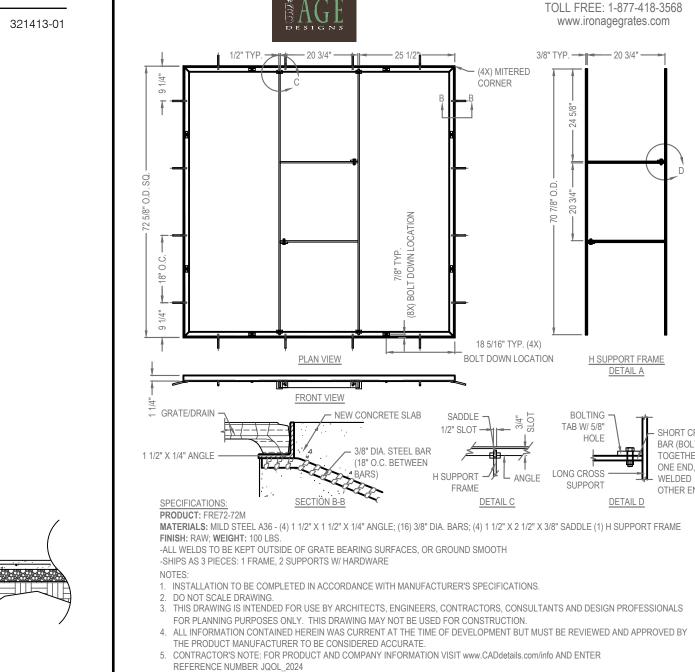

PAVER DETAIL CONCRETE BASE UNILOCK PAVER -W/BITUMINOUS SETTING BED

L-GRAVEL AT BASE OF TREE

TREE GRATE WITH FRAME

(DO NOT BUILD UP ON BELL OF TREE)

CONCRETE PAVER BASE W/

1" BITUMINOUS SETTING BED

---- UNDISTURBED SUBGRADE

— UNILOCK PAVERS

BEIGE CONCRETE SEE CIVIL

TURN DOWN EDGE AT PAVERS

EXPANSION

#4 REBAR 24" O.C.

TREE COURTYARD ELEVATION

323353-01

8471RA Retractable Bollard Assembl


471R Retractable Bollard Receiver

RETRACTABLE BOLLARD

PAVER DETAIL

329443-03

TREE GRATE FRAMES TREE GRATE 'E' EMBEDMENT FRAME: 6' X 6'

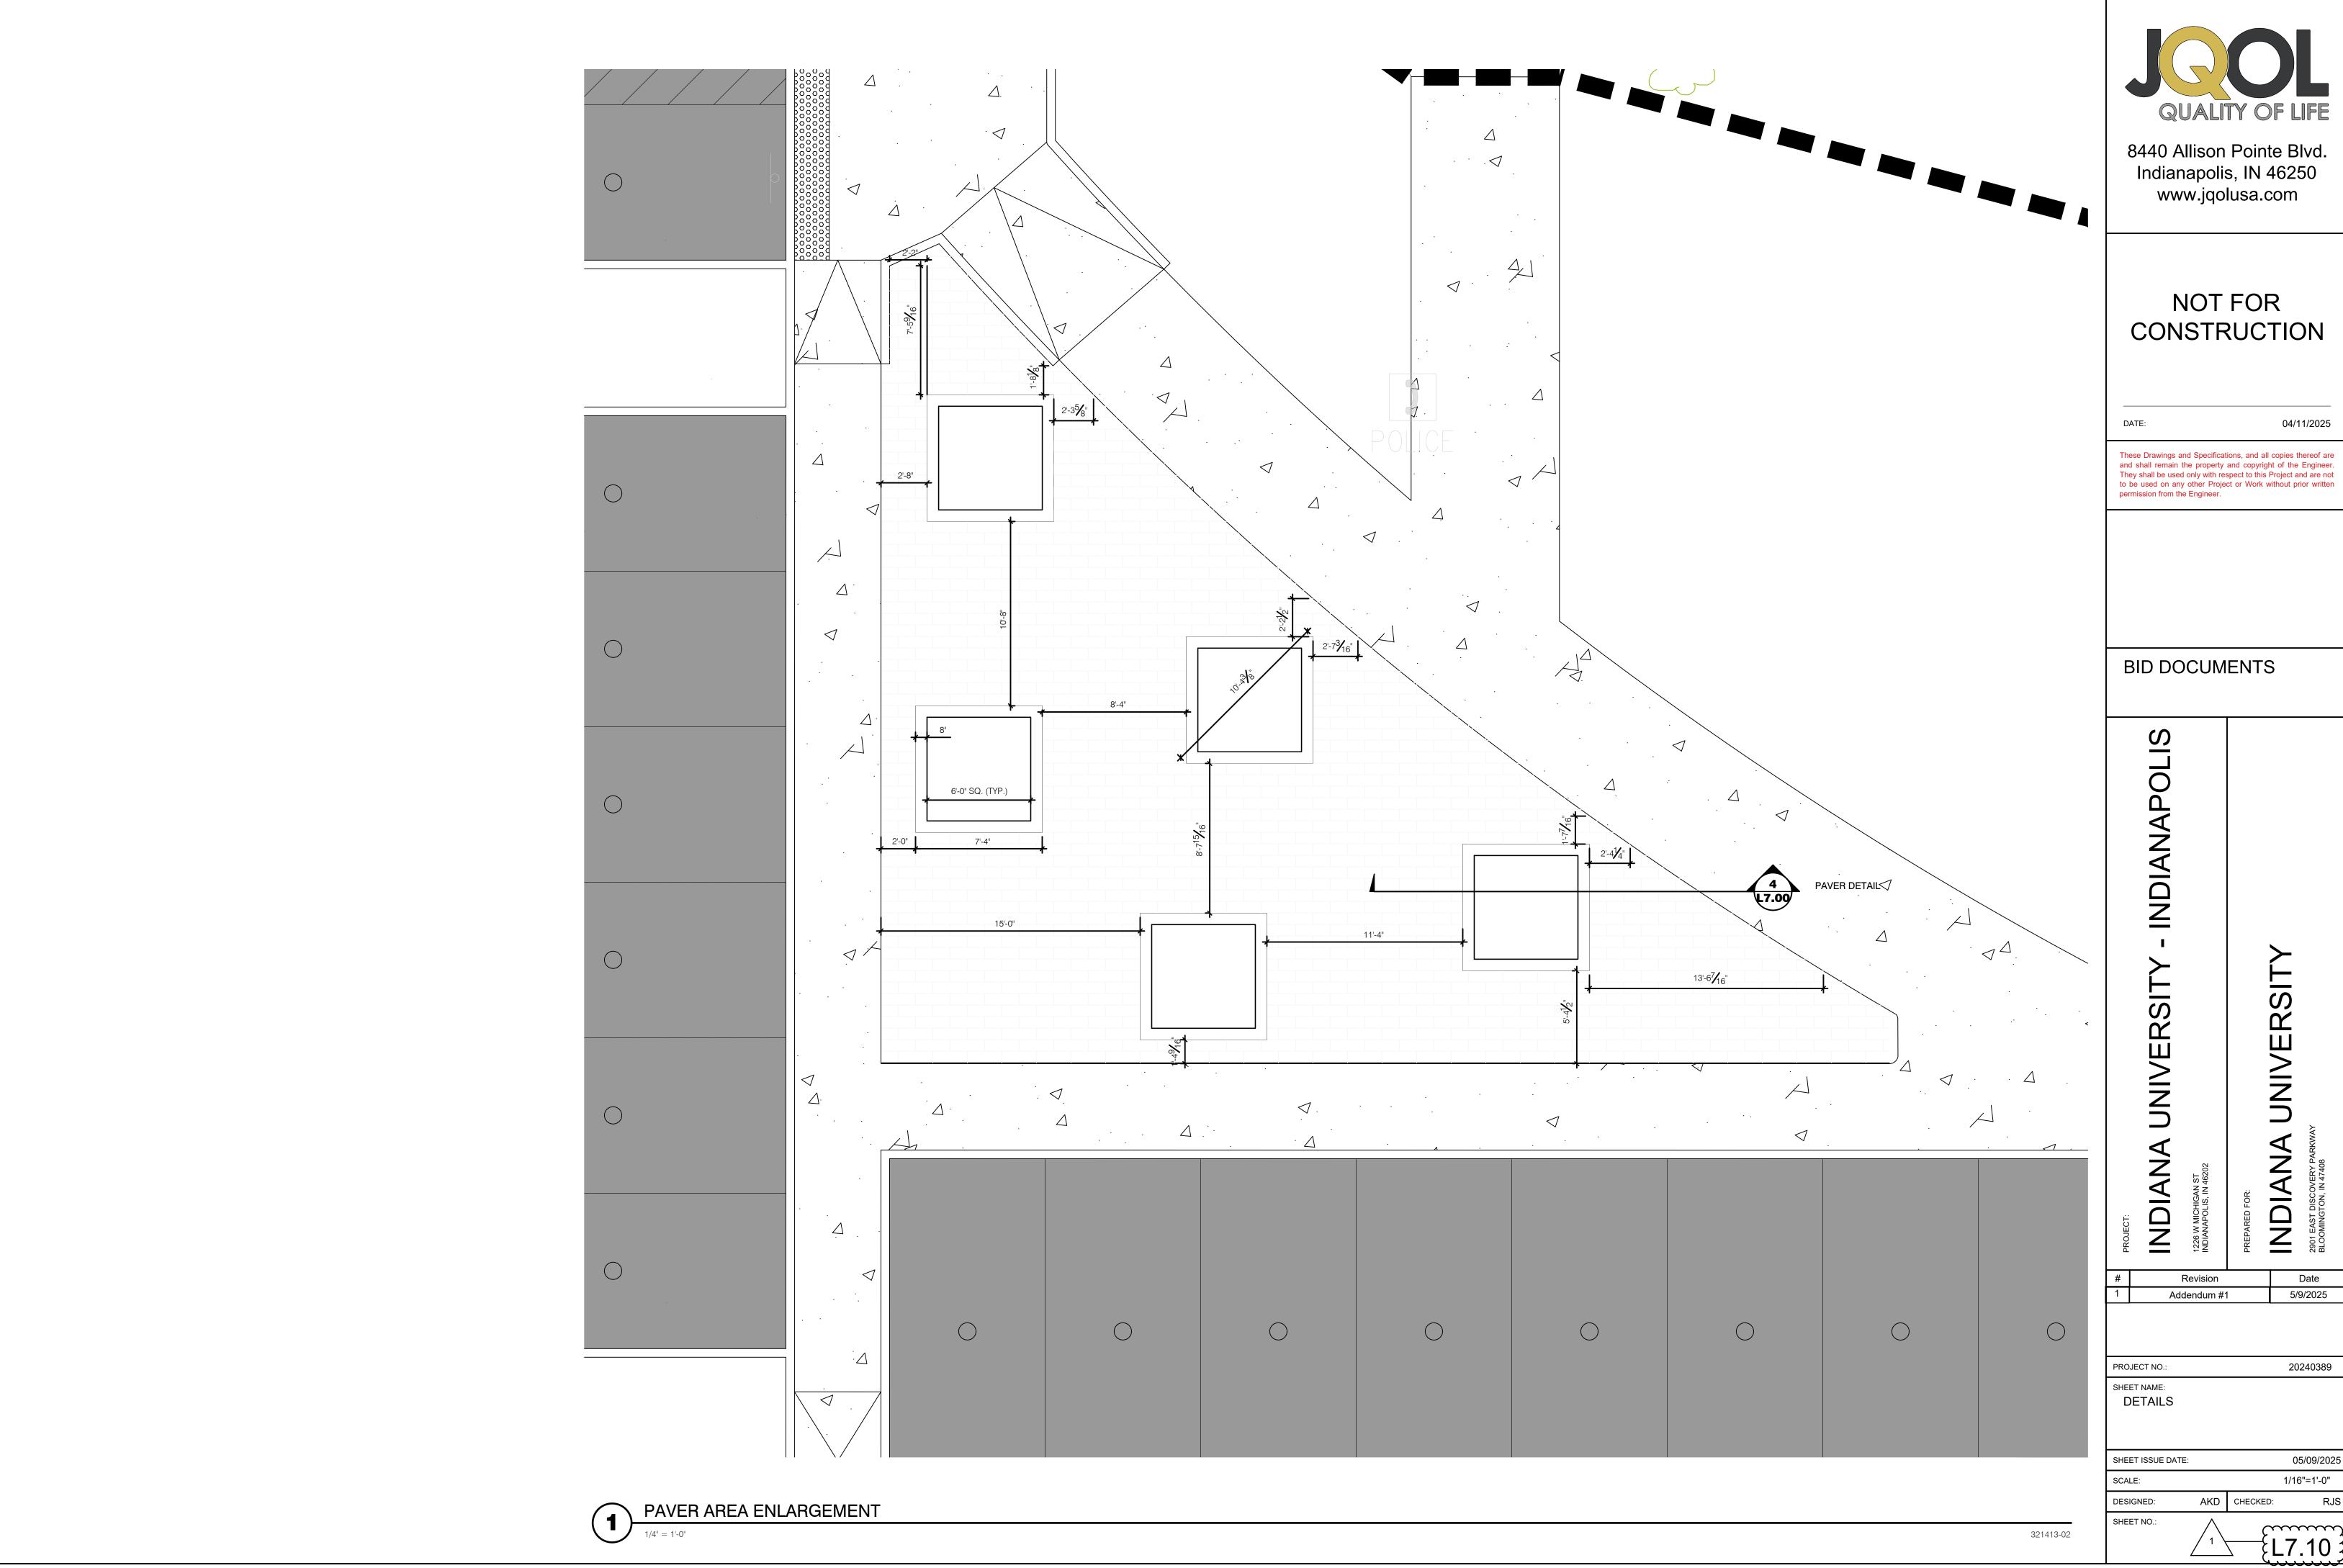

5/9/2025

1/16"=1'-0"

| LIGHT FIXTURE SCHEDULE |  |         |                  |                                   |      |     |               |  |         |
|------------------------|--|---------|------------------|-----------------------------------|------|-----|---------------|--|---------|
| TAG                    | MANUFACTURER'S CATALOG NUMBER  | VOLTAGE | MOUNT            | MIN.<br>LUMEN<br>OUTPUT<br>*(D/I) | СТ   | CRI | MAX.<br>WATTS | DESCRIPTION  | REMARKS |
| SL1                    | BEACON #VP-2-320L-145-4K7-2-UNV-DB-SCP MCGRAW-EDISON #GLEON SERIES   | MVOLT   | EXISTING<br>POLE | 22,097                            | 4000 | 70  | 146           | DIE CAST ALUMINUM FIXTURE WITH POWDER COAT BRONZE FINISH, PROVIDE ADAPTER AS REQUIRED FOR POLE MOUNTING. PROVIDE CUSTOM MOUNTING PLATE AS REQUIRED. PROVIDE WITH WIRELESS HANDHELD CONFIGURATION TOOL.   |         |
| SL2                    | BEACON #VP-2-320L-145-4K7-5QW-UNV-DB-SCP MCGRAW-EDISON #GLEON SERIES | MVOLT   | EXISTING<br>POLE | 22,097                            | 4000 | 70  | 146           | DIE CAST ALUMINUM FIXTURE WITH POWDER COAT BRONZE FINISH, PROVIDE ADAPTER AS REQUIRED FOR POLE MOUNTING. PROVIDE CUSTOM MOUNTING PLATE AS REQUIRED. PROVIDE WITH WIRELESS HANDHELD CONFIGURATION TOOL.   |         |
| SL3                    | BEACON #VP-2-320L-145-4K7-2-UNV-DB-SCP MCGRAW-EDISON #GLEON SERIES   | MVOLT   | NEW POLE         | 22,097                            | 4000 | 70  | 146           | DIE CAST ALUMINUM FIXTURE WITH POWDER COAT BRONZE FINISH, PROVIDE ADAPTER AS REQUIRED FOR POLE MOUNTING. PROVIDE BEACON "RSA" SERIES 30'-0" TALL BY 6" DIAMETER ROUND STRAIGHT ALUMINUM WITH DARK BRONZE FINISH. POLE SHALL BE CONSTRUCTED OF SEAMLESS ROUND EXTRUDED ALUMINUM. THE POLE SHAFT SHALL TELESCOPE INTO THE BASE CASTING AND SHALL BE CIRCUMFERENTIALLY WELEDED TOP AND BOTTOM, THE BASE SHALL BE HINGED. FURNISH WITH ROUND ALUMINUM BASE COVER, POLE CAP. REINFORCED HANDHOLE AT +18", AND GROUND LUG LOCATED NEAR HANDHOLE. POLE SHALL BE COMPLETE WITH INTERNAL VIBRATION DAMPERS. PROVIDE CUSTOM MOUNTING PLATE AS REQUIRED. PROVIDE WITH WIRELESS HANDHELD CONFIGURATION TOOL. FIELD VERIFY EXISTING POLE HEIGHTS ON SITE. |         |
| REMARKS:               |  |         |                  |                                   |      |     |               |  |         |
|                        |  |         |                  |                                   |      |     |               |  |         |

- PROVIDE WITH PENTA HEAD

- HEAVY DUTY COVER WITH SKID RESISTANT FINISH MARKED

FINISHED GRADE

18" GRAVEL FOR DRAINAGE

"ELECTRIC".

STAINLESS STEEL BOLTS

NOTES:

PROVIDE TIER 15 RATED UNITS IN

2. PROVIDE TIER 22 RATED UNITS IN

HANDHOLES INTO BUILDINGS TO BE

SPLICING-CONDUCTORS TO

BE WATER TIGHT. SEAL CONDUIT

CONDUIT

NEW ELECTRICAL-

WITH RTV OR

PLUG FITTING.

3. CONDUITS EXTENDED FROM

GRASS AREAS.

CONCRETE AREAS.

PVC COATED RMC.

CONDUCTORS

THIS MONOCHROME

PRINT SHOULD

DISPLAY

GRAYSCALE BOXE

BELOW IF PRINTED

PROPERLY WITH

#### **GENERAL NOTES:**

- ELECTRICAL CONTRACTOR IS TO PROVIDE ALL NECESSARY HARDWARE AND ACCESSORIES FOR COMPLETE INSTALLATION OF LIGHT FIXTURES ACCORDING TO MANUFACTURER'S RECOMMENDATIONS.
- FULL MODEL NUMBER(S) LISTED ABOVE ARE BASIS OF DESIGN. CONTRACTOR IS RESPONSIBLE FOR DEVIATION FROM BASIS OF DESIGN.

ELECTRICAL CONTRACTOR IS RESPONSIBLE TO PROVIDE ADDITIONAL CIRCUIT(S) AS REQUIRED FOR MAX. WATTAGE IN EXCESS OF BASIS OF DESIGN.

#### **ELECTRICAL SYMBOLS SCHEDULE**

EXTERIOR POLE MOUNTED FIXTURE, "XX" DENOTES FIXTURE TYPE

## EXTERIOR POLE, POST MOUNTED FIXTURE, "XX" DENOTES FIXTURE TYPE

#### GENERAL ELECTRICAL DEMOLITION NOTES

- ALL EXISTING EQUIPMENT THAT IS TO REMAIN IS INTENDED TO BE OPERATIONAL AT THE COMPLETION OF THE PROJECT. RECIRCUIT WHERE NECESSARY TO INSURE THIS CONTINUED OPERATION.
- OWNER SHALL HAVE FIRST RIGHT OF REFUSAL ON ALL EQUIPMENT THAT IS TO BE REMOVED.
- THE EXISTING EQUIPMENT SHOWN ON THE DRAWINGS IS BELIEVED TO BE A REASONABLE INDICATION OF THE EXISTING LAYOUT. EXACT QUANTITY AND LOCATION SHALL BE FIELD VERIFIED BY CONTRACTOR.

#### **GENERAL ELECTRICAL NOTES**

#### 1. REFER TO ARCHITECTURAL PLANS FOR DIMENSIONS.


- 2. DIMENSIONS SHOWN ON OUTLET BOXES AND DEVICES SHALL BE TO THE BOTTOM OF THE BOX.
- 3. CONDUIT SHOWN TO LIGHT FIXTURES IS SHOWN TO INDICATE SWITCHING AND DOES NOT REPRESENT THE QUANTITY OR EXACT LOCATION OF WIRING AND/OR CONDUIT.
- 4. THE ELECTRICAL LAYOUT DRAWINGS ARE DIAGRAMMATIC IN NATURE. REFER TO ENTIRE CONSTRUCTION DRAWING SET AND SPECIFICATIONS FOR GUIDANCE ON DIMENSIONS, CEILING HEIGHTS, DOOR SWINGS, ROOM FINISHES, STRUCTURAL DETAILS, LOCATIONS OF PIPING, DUCTWORK, STRUCTURAL MEMBERS, AND OTHER OBSTRUCTIONS. INSTALL THE ELECTRICAL SYSTEMS SO AS NOT TO INTERFERE WITH THE INSTALLATION OR FUNCTION OF ANY WORK BY ANOTHER DISCIPLINE.
- 5. ALL DIMENSIONS OF EXISTING DEVICES AND EQUIPMENT ARE APPROXIMATE. CONTRACTOR SHALL MAKE ALL NECESSARY FIELD MEASUREMENTS OF EXISTING STRUCTURES AND EQUIPMENT TO VERIFY DIMENSIONS SHOWN ON THE PLANS. ALL ADDED COSTS TO MODIFY NEW CONSTRUCTION DUE TO A LACK OF COORDINATION AND FIELD MEASUREMENTS SHALL BE BORNE BY THE CONTRACTOR.
- 6. COORDINATE ALL EQUIPMENT WIRING WITH MFR'S REQUIREMENTS. CHANGES REQUIRED FROM THE USE OF PRODUCTS THAT ARE OTHER THAN THE BASIS OF DESIGN SHALL BE BORNE BY THE CONTRACTOR.
- SIZING OF BRANCH CIRCUITS AND FEEDERS FOR EQUIPMENT IS BASED ON DESIGN LOADS. PRIOR TO INSTALLATION, CONFIRM EXACT LOADS WITH RELEASED SHOP DRAWINGS. BRING ANY DISCREPANCIES TO THE ATTENTION OF THE
- 8. BRANCH CIRCUITS SHALL BE WIRED WITH 3/4"C, 2-#12, 1-#12G, UNLESS NOTED OTHERWISE. NEUTRAL CONDUCTORS SHALL NOT BE SHARED ON BRANCH CIRCUITS.
- 9. WHERE CONDUIT AND WIRING HAS NOT BEEN SHOWN ON THE DRAWINGS, THE ARRANGEMENT AND ROUTING OF LIGHTING AND RECEPTACLE BRANCH CIRCUITS SHALL BE AT THE DISCRETION OF CONTRACTOR IN ACCORDANCE WITH GENERALLY ACCEPTED GOOD PRACTICE, N.E.C. REQUIREMENTS, AND THE FOLLOWING LIMITATIONS:
- 10. EXCEPT WHERE NOTED OTHERWISE, SIZE BRANCH CIRCUIT CONDUCTORS WITHIN THE FOLLOWING MAXIMUM LENGTH LIMITS: (MEASURE TO THE CENTER OF THE LOAD FOR LIGHTING AND TO THE MOST REMOTE OUTLET FOR RECEPTACLE


CONDUCTOR SIZE

CIRCUIT BREAKER 120V, 20 A


CIRCUIT LENGTH 100 FEET 150 FEET 200 FEET

- 11. PROVIDE #12 AWG MINIMUM FOR BRANCH CIRCUITS. PROVIDE ADDITIONAL DERATING PER N.E.C. TABLES 310-16 THROUGH 310-31 FOR ALL HOME RUNS WITH MORE THAN THREE CURRENT CARRYING CONDUCTORS IN A RACEWAY
- 12. CONDUITS SHALL BE LIMITED TO A MAXIMUM OF NINE BRANCH CIRCUIT CONDUCTORS OF WHICH A MAXIMUM OF FOUR PHASE CONDUCTORS SHALL BE PERMITTED. GROUNDING CONDUCTORS SHALL NOT BE INCLUDED IN THE COUNT.

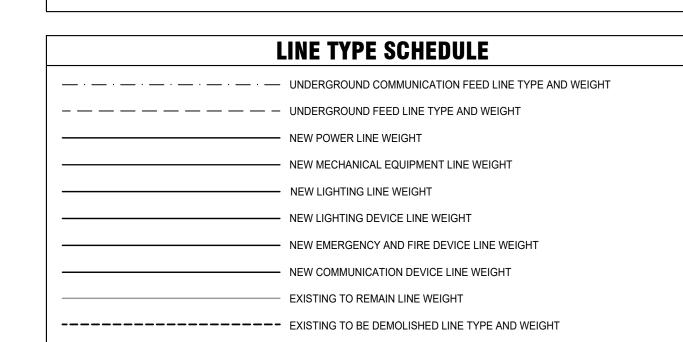


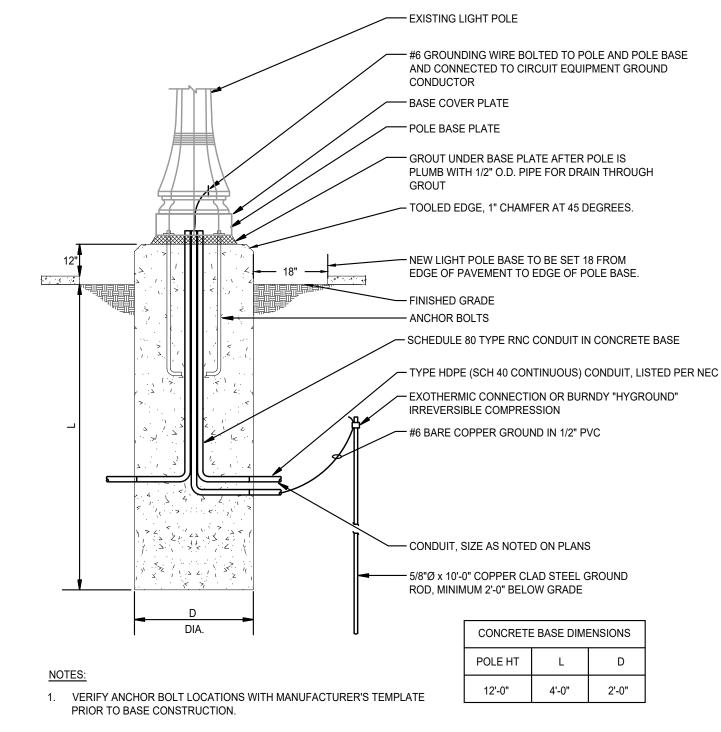


- 2. REFER TO POLE BASE CONCRETE AND REINFORCING DETAIL FOR ADDITIONAL REQUIREMENTS. SEE DETAIL #5 ON THIS SHEET.
- 3. FORM TO BE SONOTUBE "FINISH FREE" TYPE. INSTALL PER MANUFACTURER'S INSTRUCTIONS. REMOVE EXPOSED SONOTUBE AFTER CONCRETE HAS CURED.
- 4. CONVERT FROM HDPE CONDUIT TO RNC CONDUIT BY MEANS OF A LISTED ADAPTER INSIDE OF CONCRETE BASE.

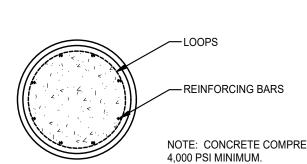

#### **PLAN VIEW**

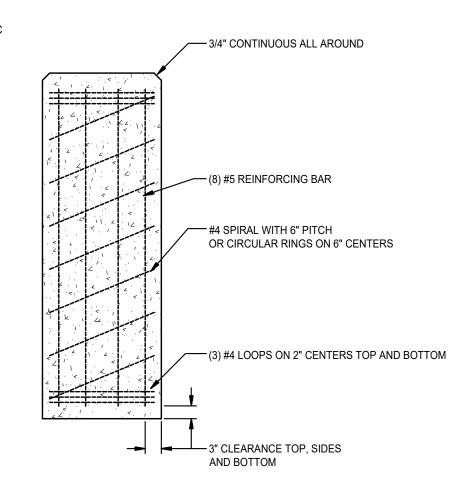

TYPICAL POLE BASE

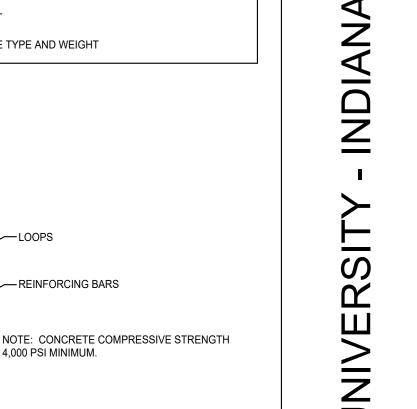

INDIAN

| Revision    | Date     |
|-------------|----------|
| Addendum #1 | 5/9/2025 |

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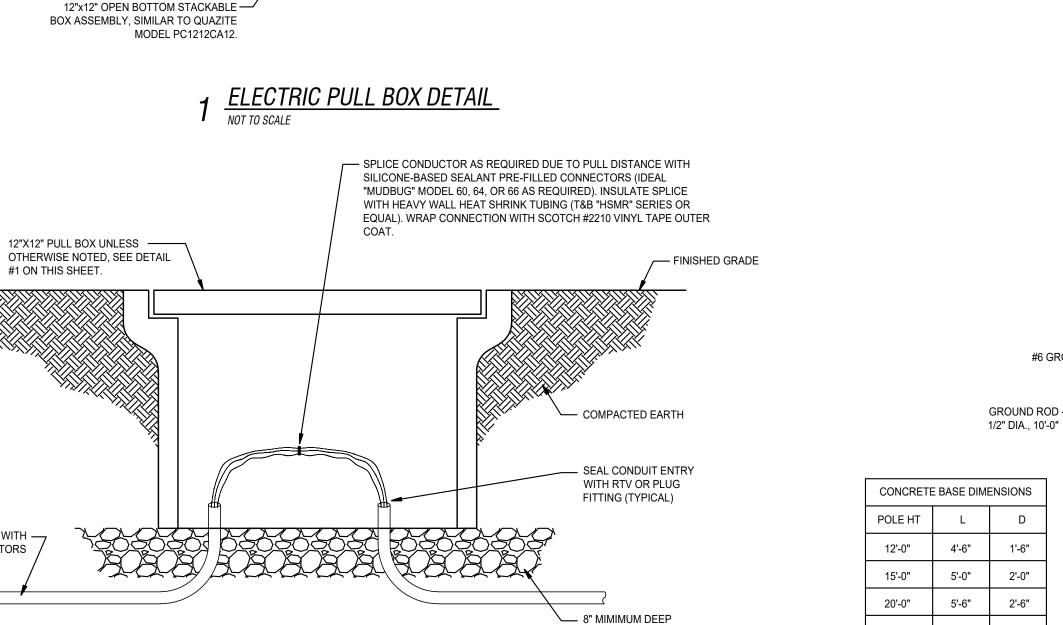
Fort Wayne, Indiana 46805

info@primary-eng.com

PROJECT NO.: NO. 20240389

INFORMATION


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GRAVEL OR CRUSHED


ROCK

2 SPLICE IN PULL BOX DETAIL



36" RAISED POLE BASE DETAIL

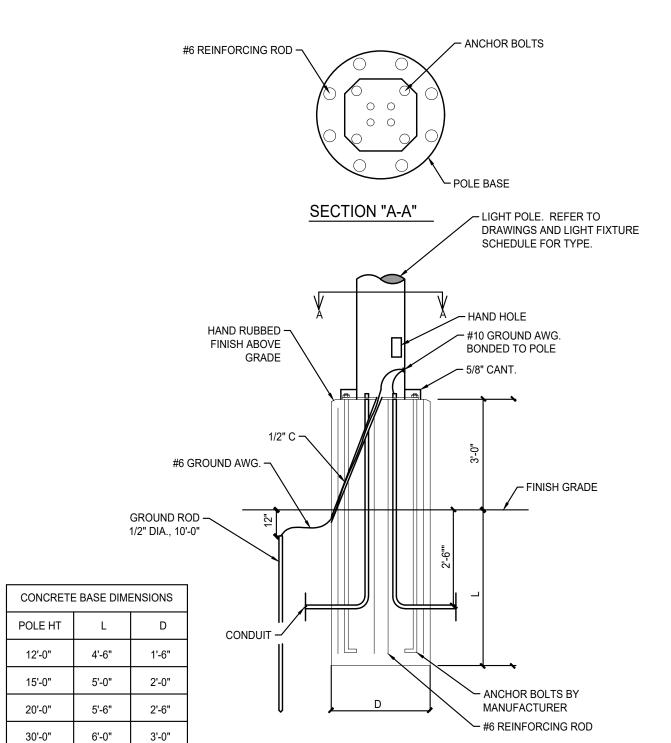NOT TO SCALE

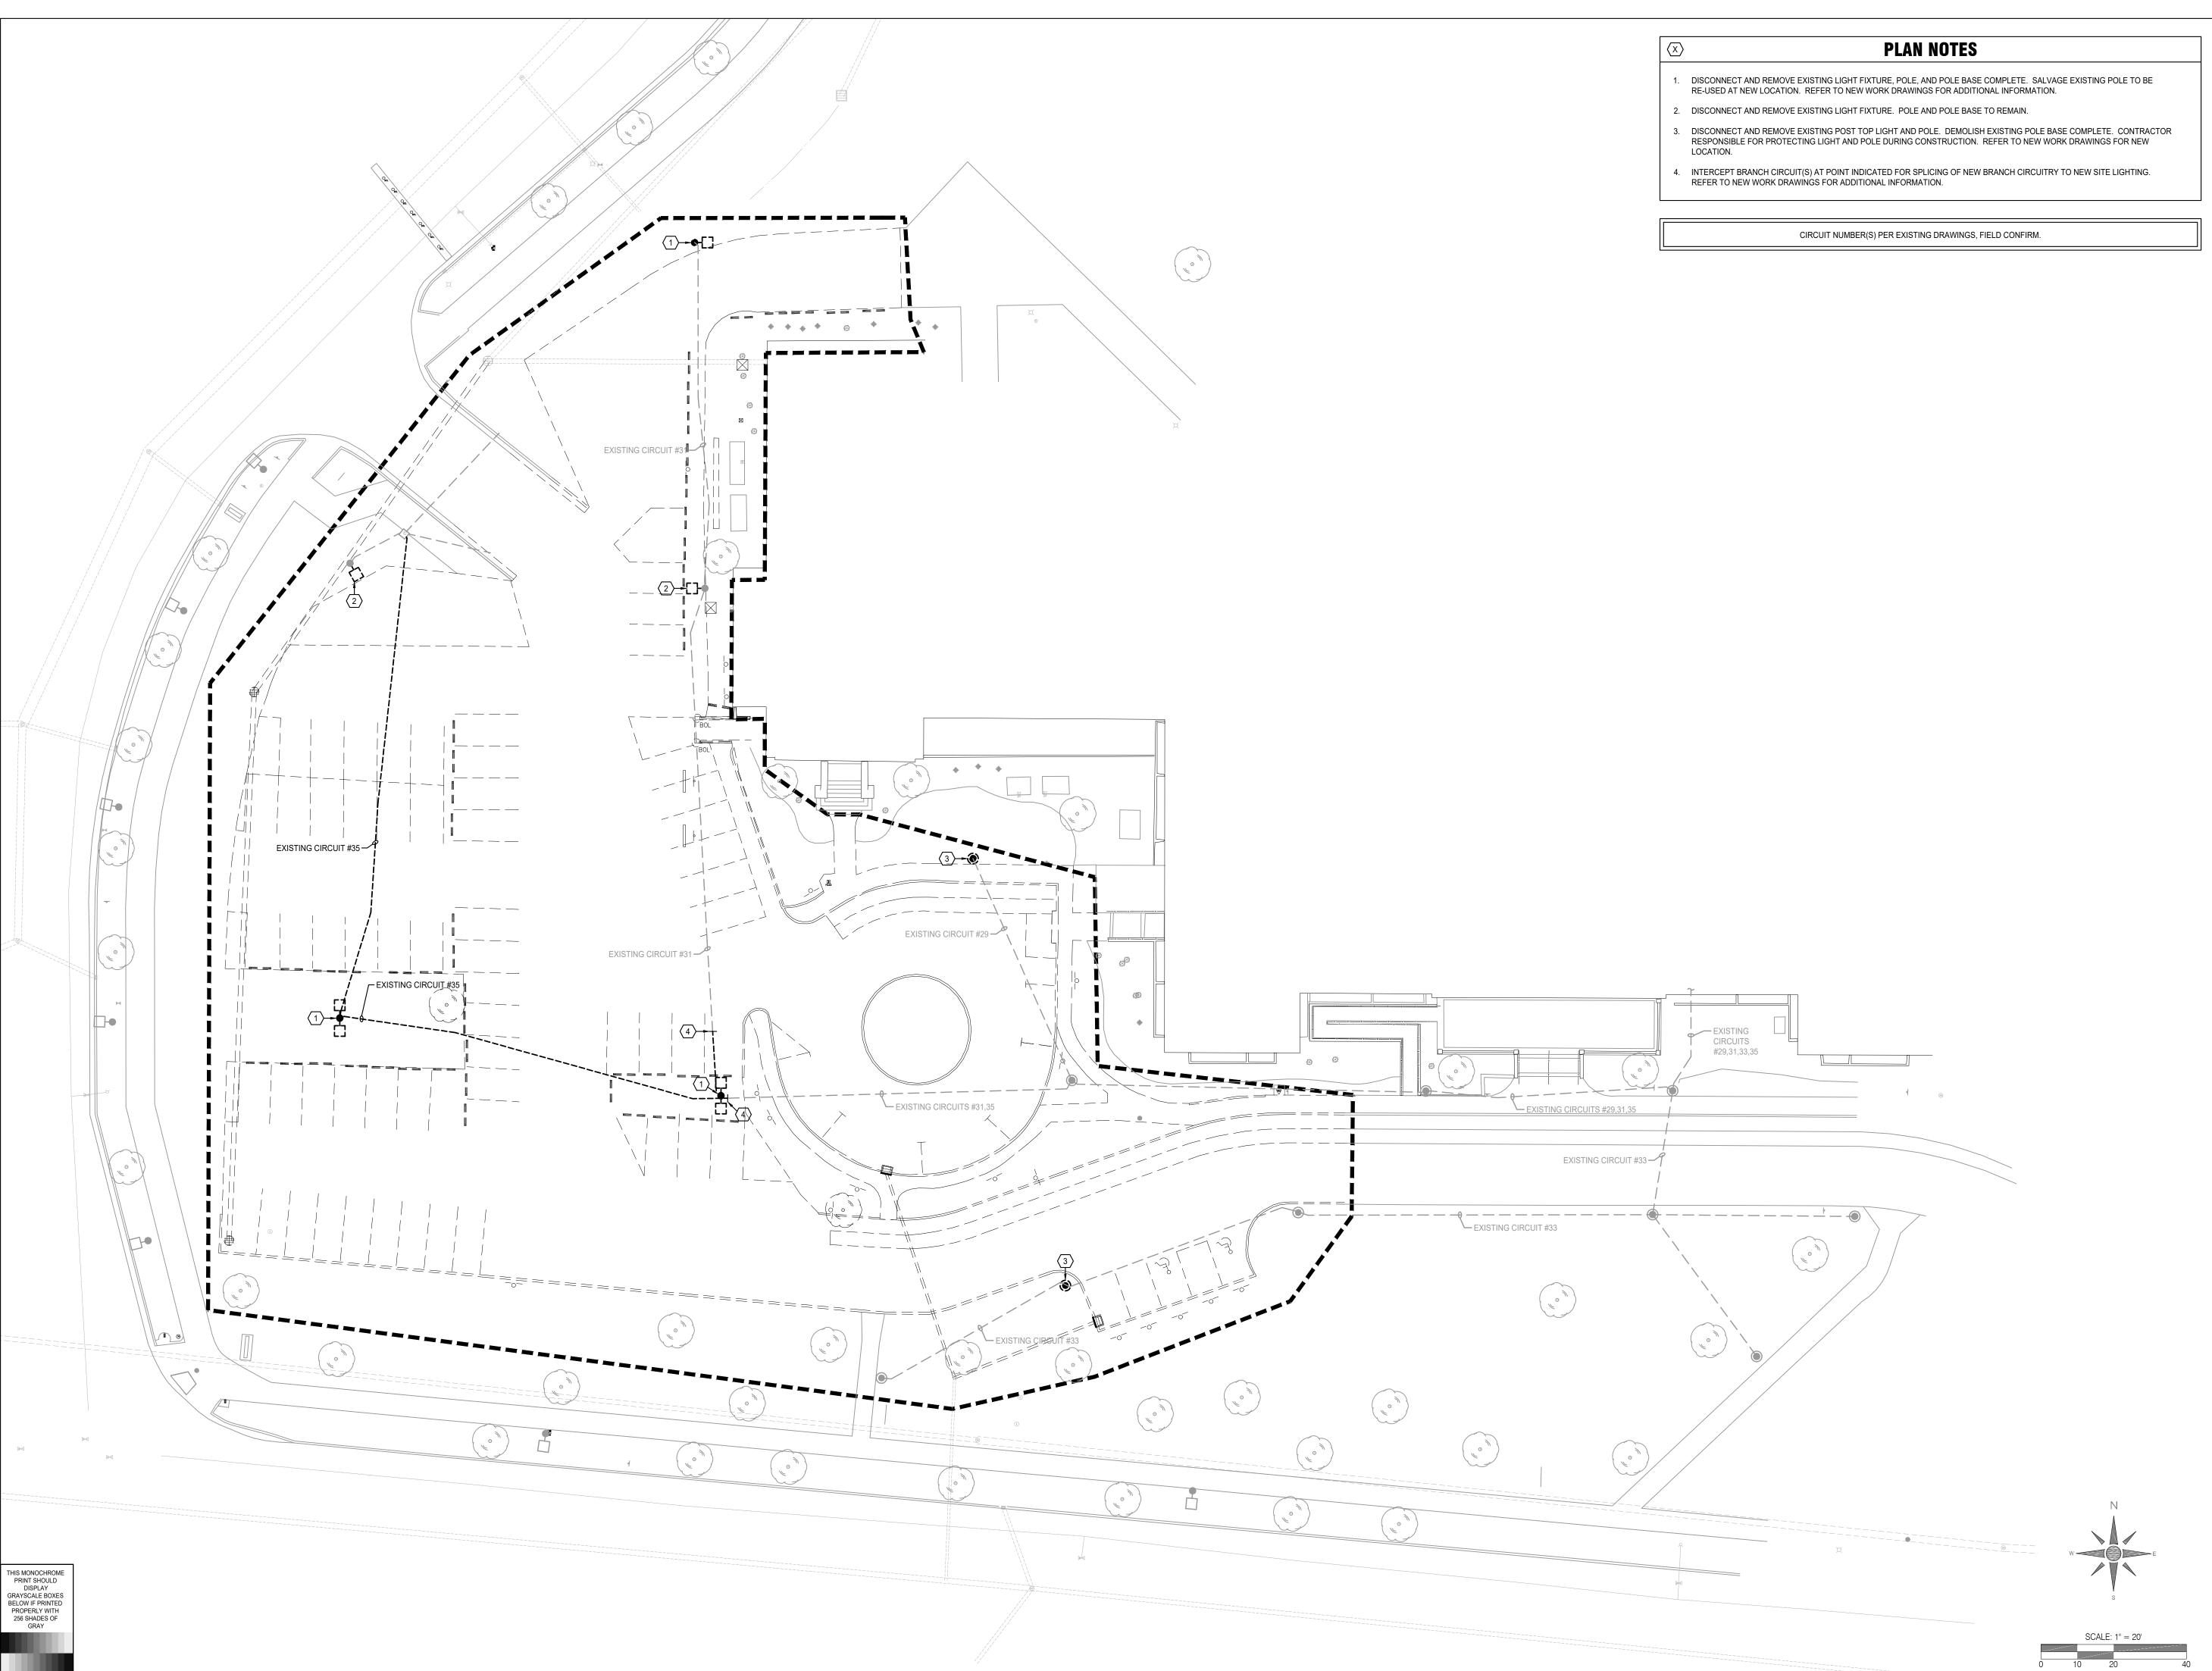



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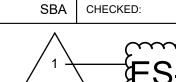
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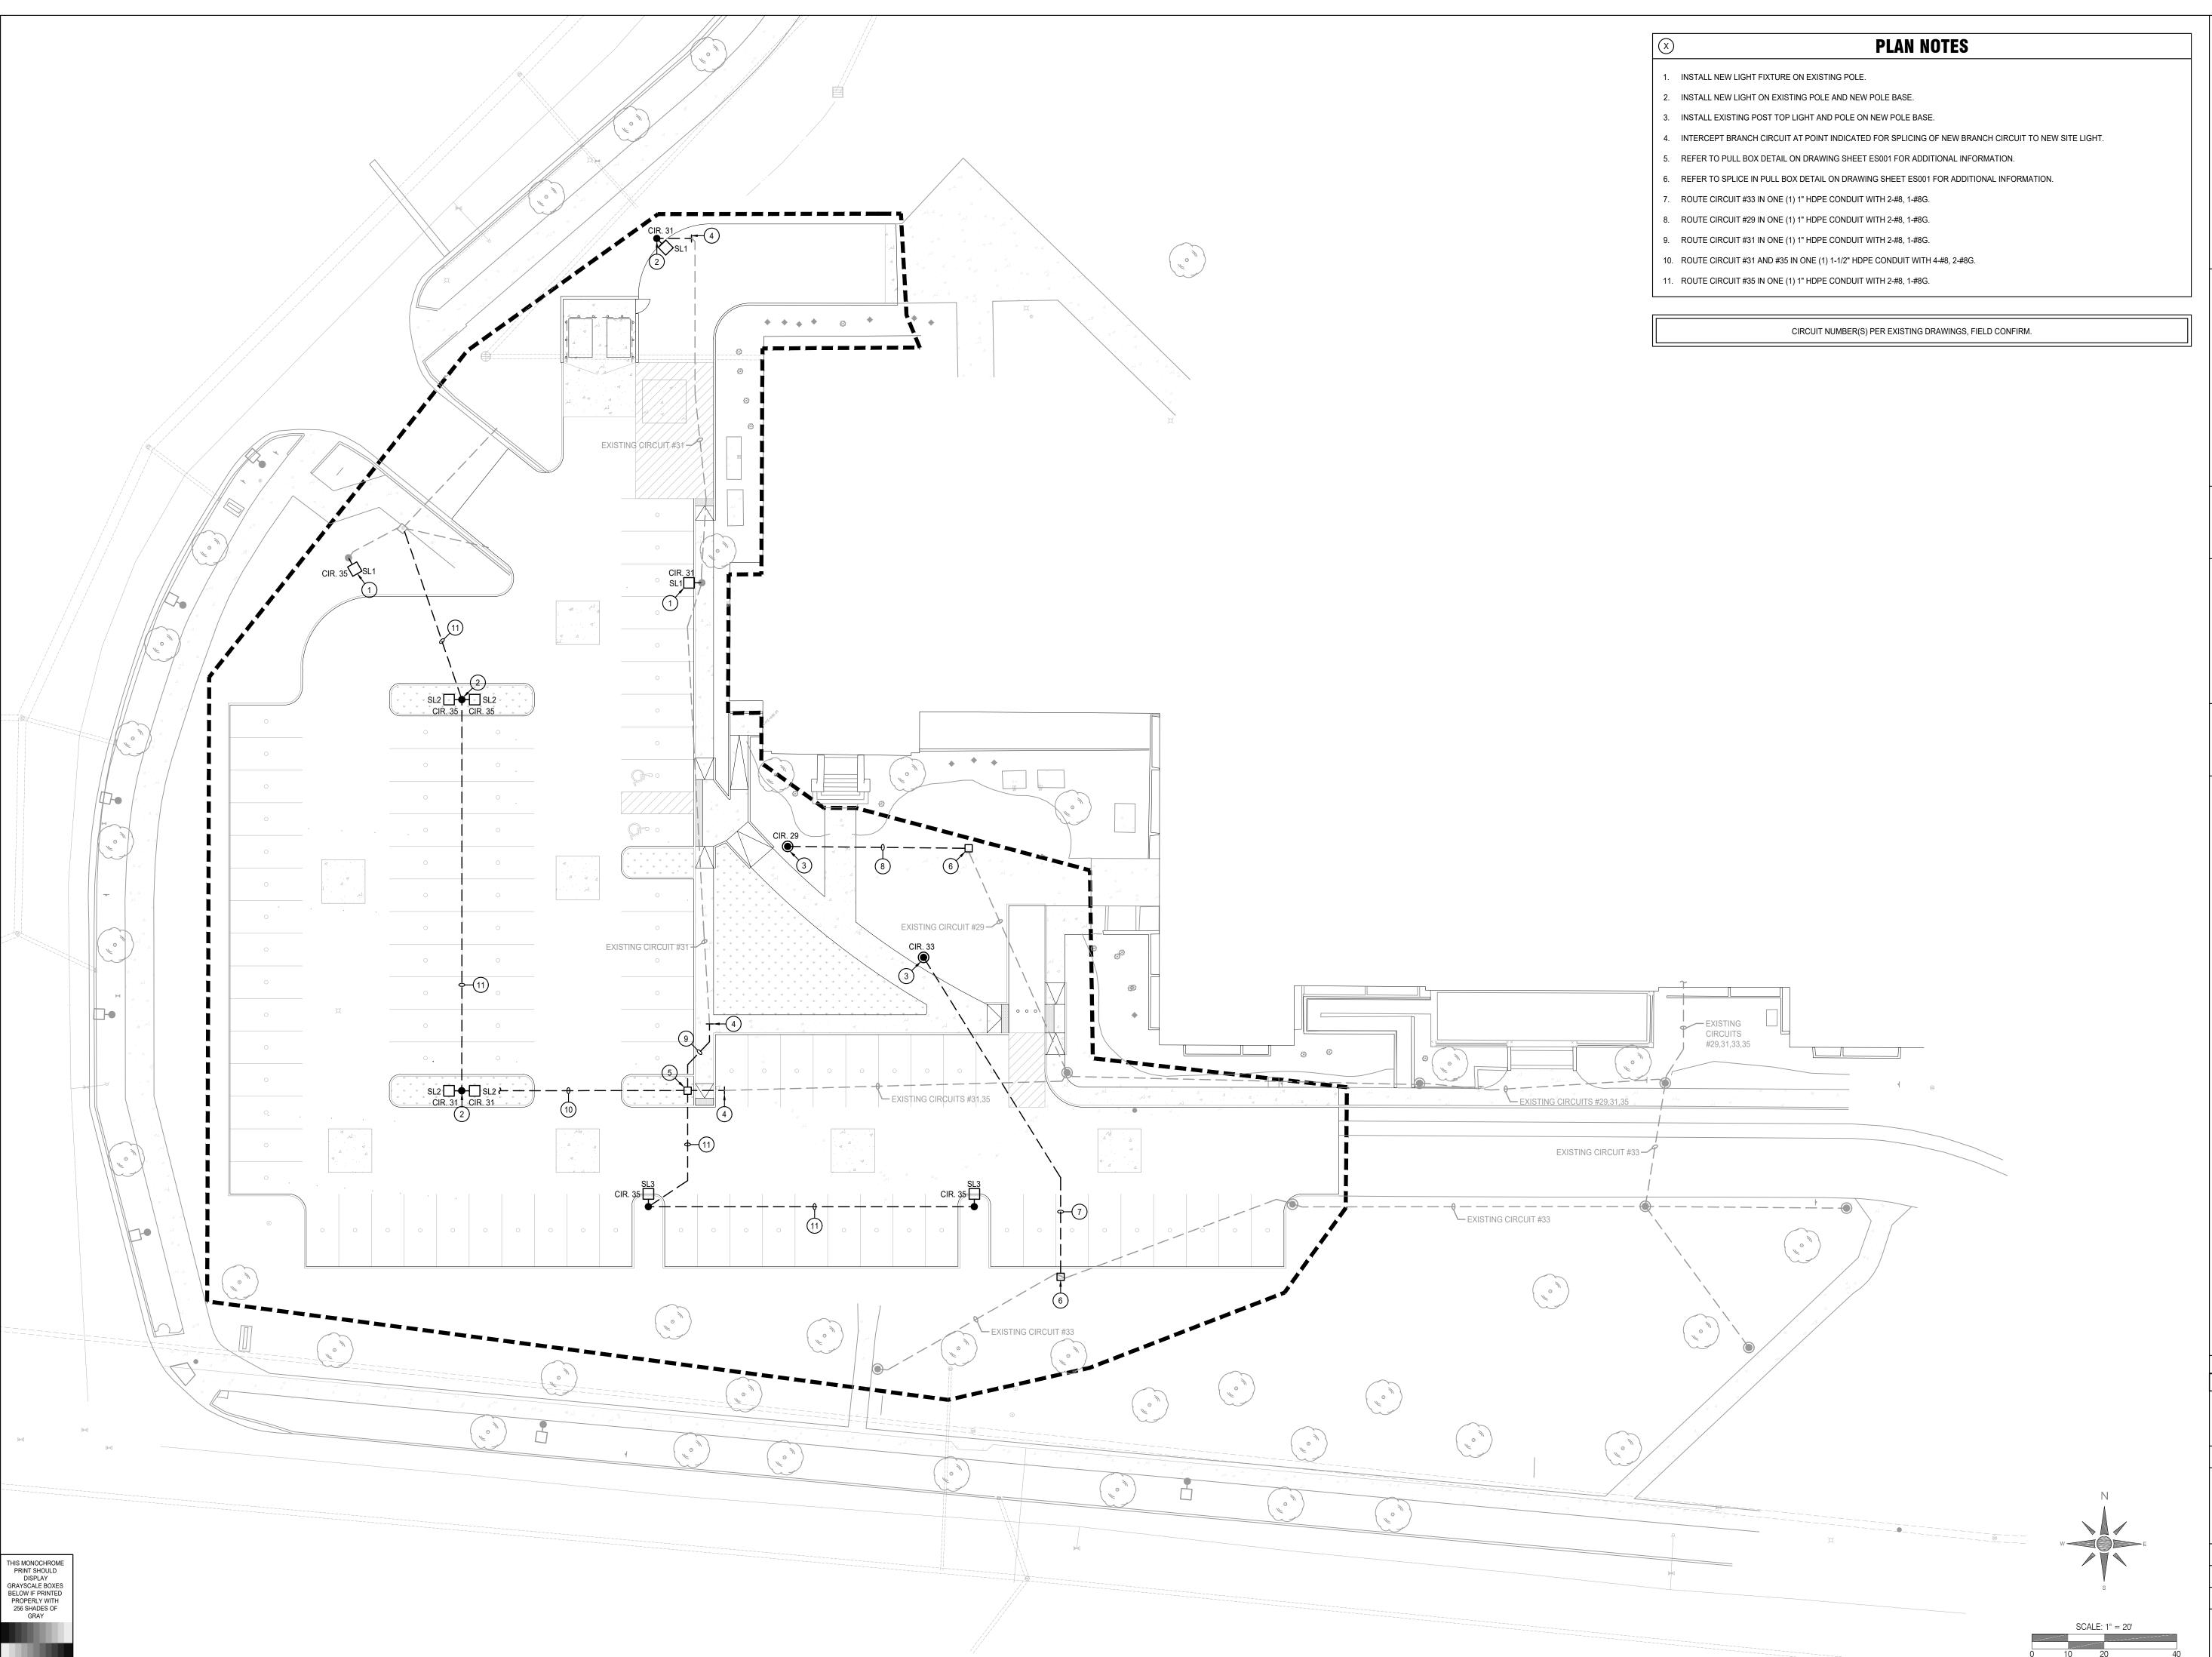
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ELECTRICAL DEMOLITION SITE PLAN

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